



NOTE:  
 ALL STEEL BRACING MEMBERS TO BE 100x100x8 RSA UNLESS STATED  
 ALL BRACING BOLTED TO WALL WITH M12 RESIN BOLTS  
 TIMBER TRUSS SUPPORTS TO BE REPLACED WITH 200X100X6 RHS  
 ALL FLOOR JOISTS AT ROOF LEVEL TO BE REMOVED

TOTAL LENGTH OF STEEL MEMBERS (APPROX) IN METERS  
 100X100X6.3 RSA = 292  
 178X102X19 UB = 25  
 200X100X6.3 RHS = 17

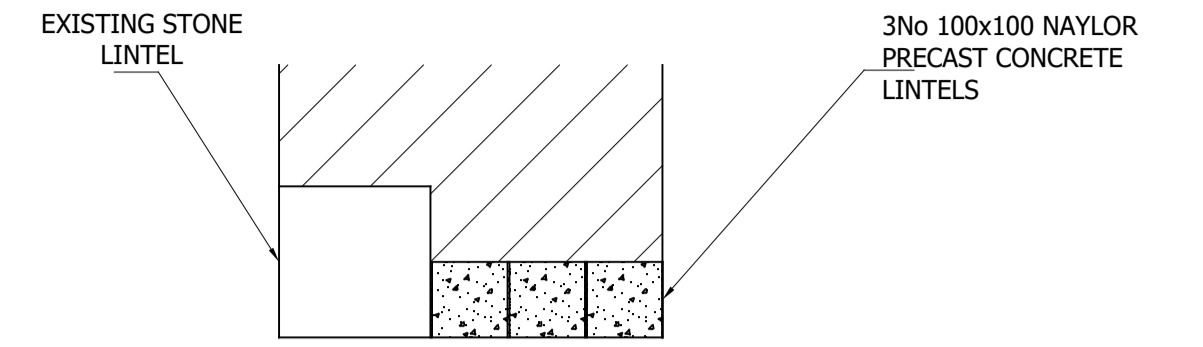


SECTION WINDOW HEAD REPAIR  
 DETAIL 'X'  
 (Scale 1:10)

FLOOR JOISTS AND  
 BOARDS IN THIS AREA  
 TO BE REMOVED

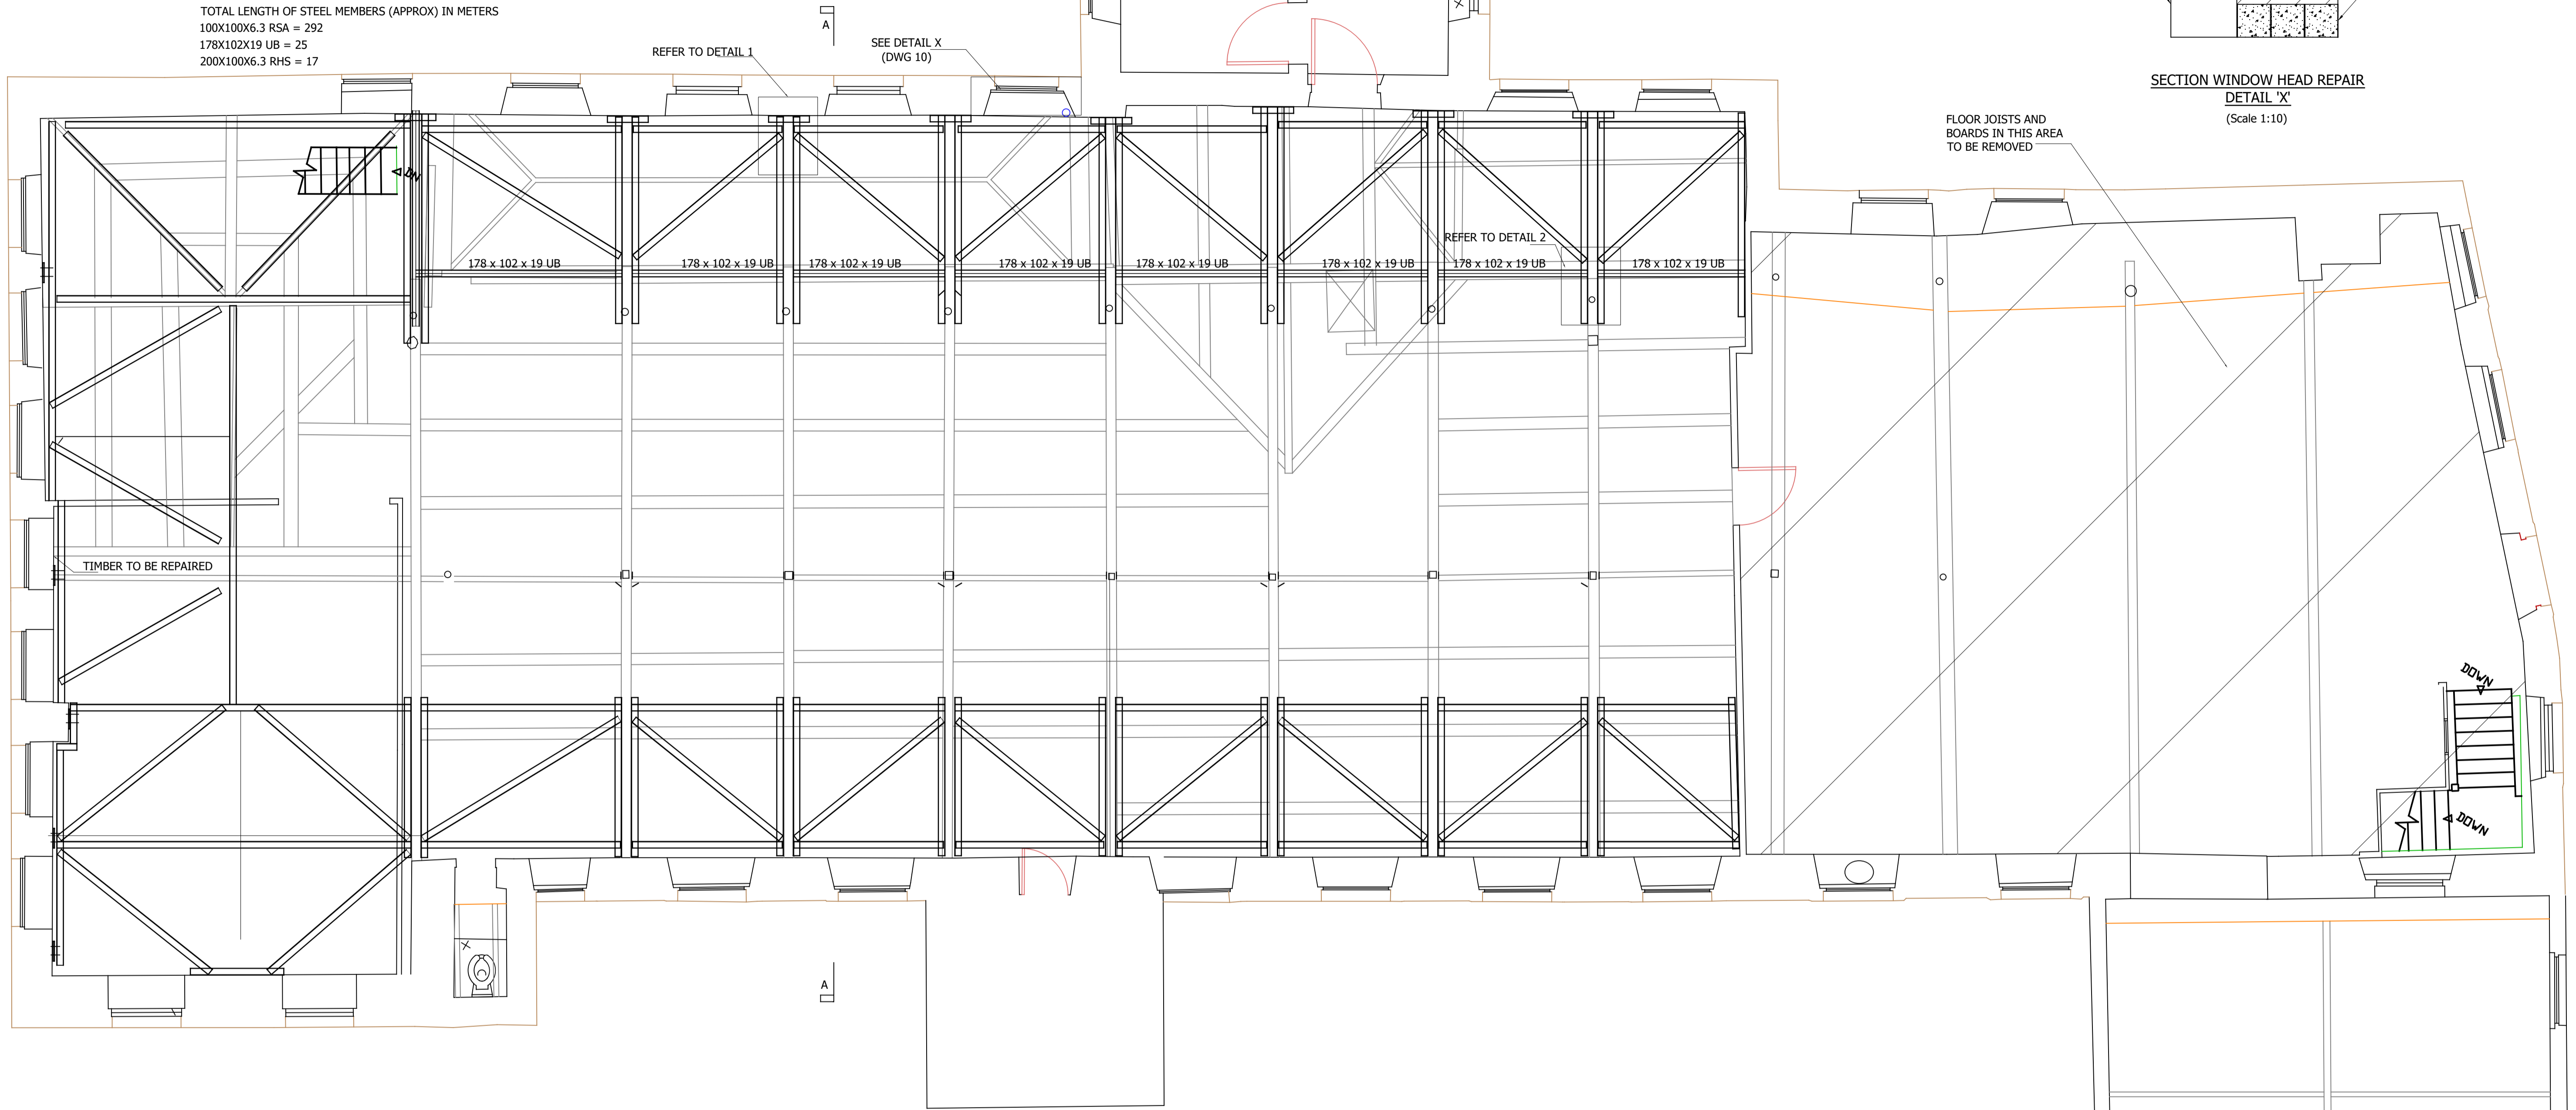

PLAN OF SECOND FLOOR SHOWING ROOF STEEL ABOVE  
 (Scale 1:50)

Client	<b>SCPI BOWLands LTD</b>		
Site	<b>CHIPPING</b>		
Project	<b>KIRK MILL</b>		
Drawing Title	<b>SECOND FLOOR PLAN WITH PROPOSED STEEL BRACING</b>		

 Civil and Structural Engineers			
The Heath Business & Technical Park, Runcorn, Cheshire WA7 4QX Tel 01928 518008 Email eng@gravitateconsulting.com			
Status :	<b>Tender</b>	Date:	<b>OCT 16</b>
Scale :	<b>AS STATED</b>	Job Number:	<b>12-155</b>
Drawn By:	<b>DW</b>	Drawing Number:	<b>08</b>
Checked By:	<b>RS</b>	Revision:	<b>A</b>