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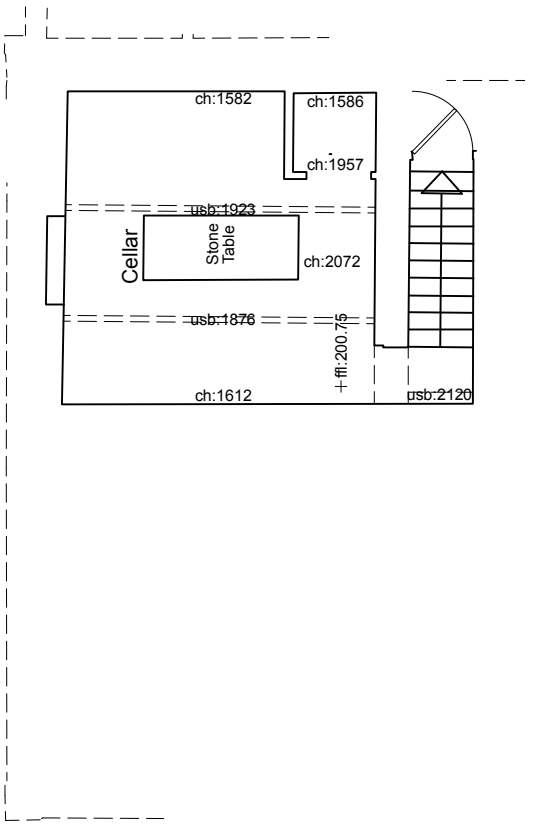
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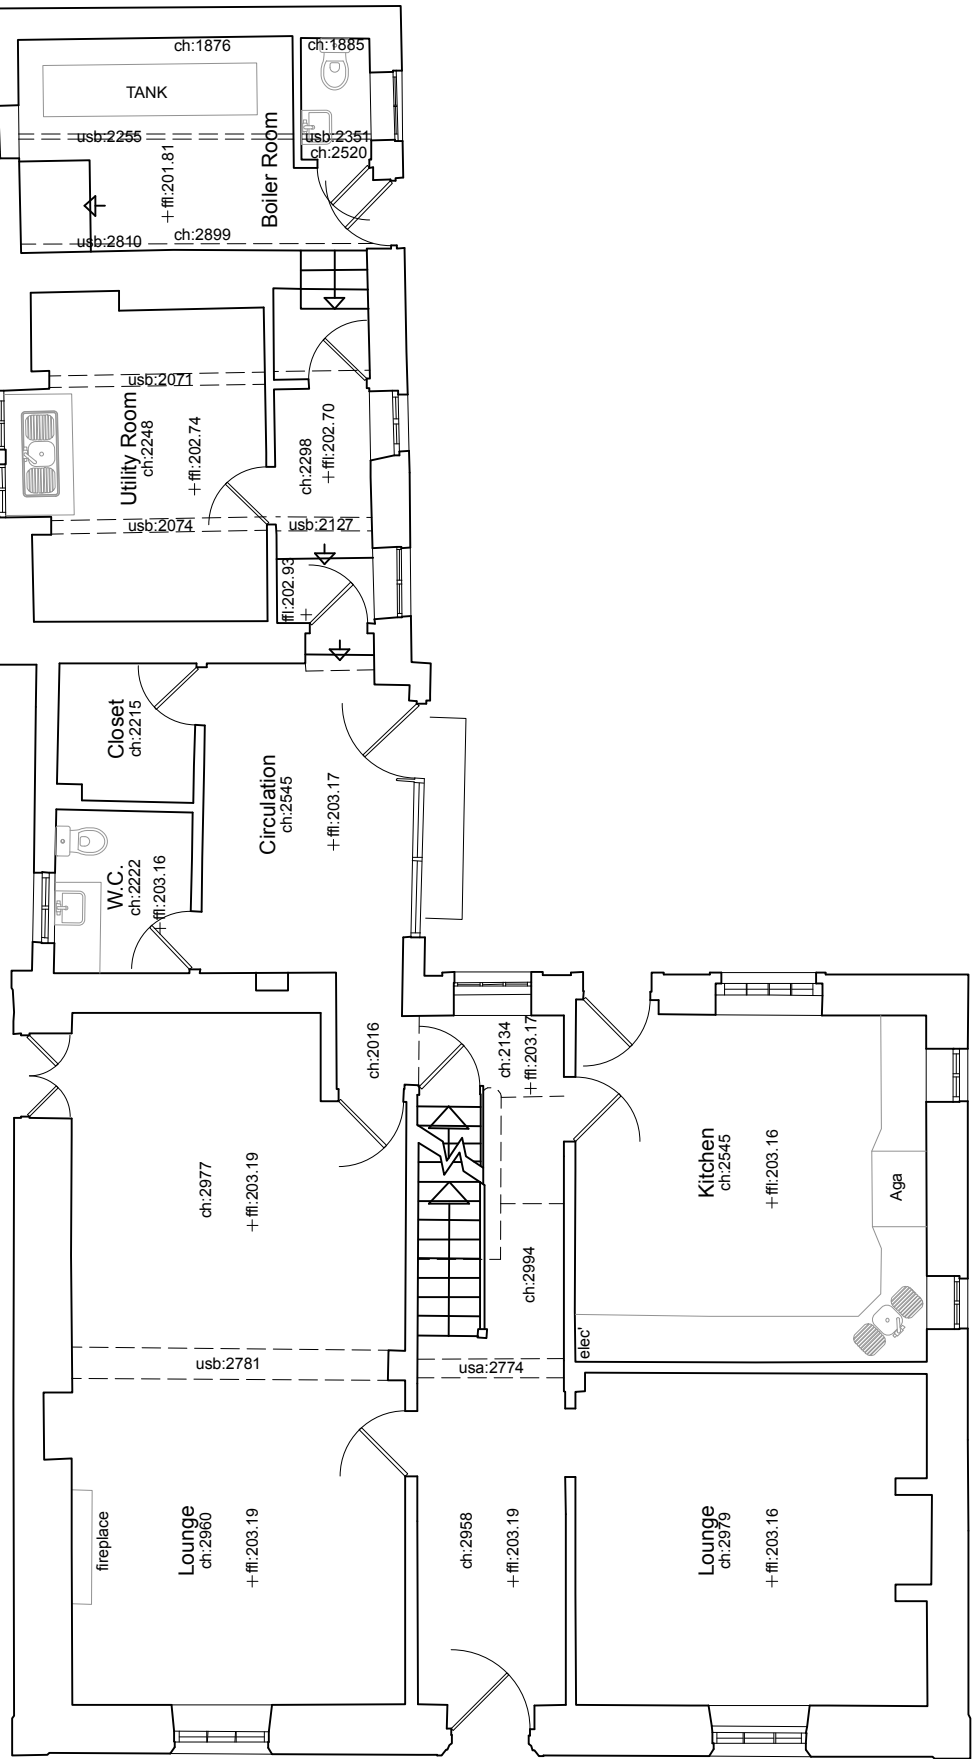
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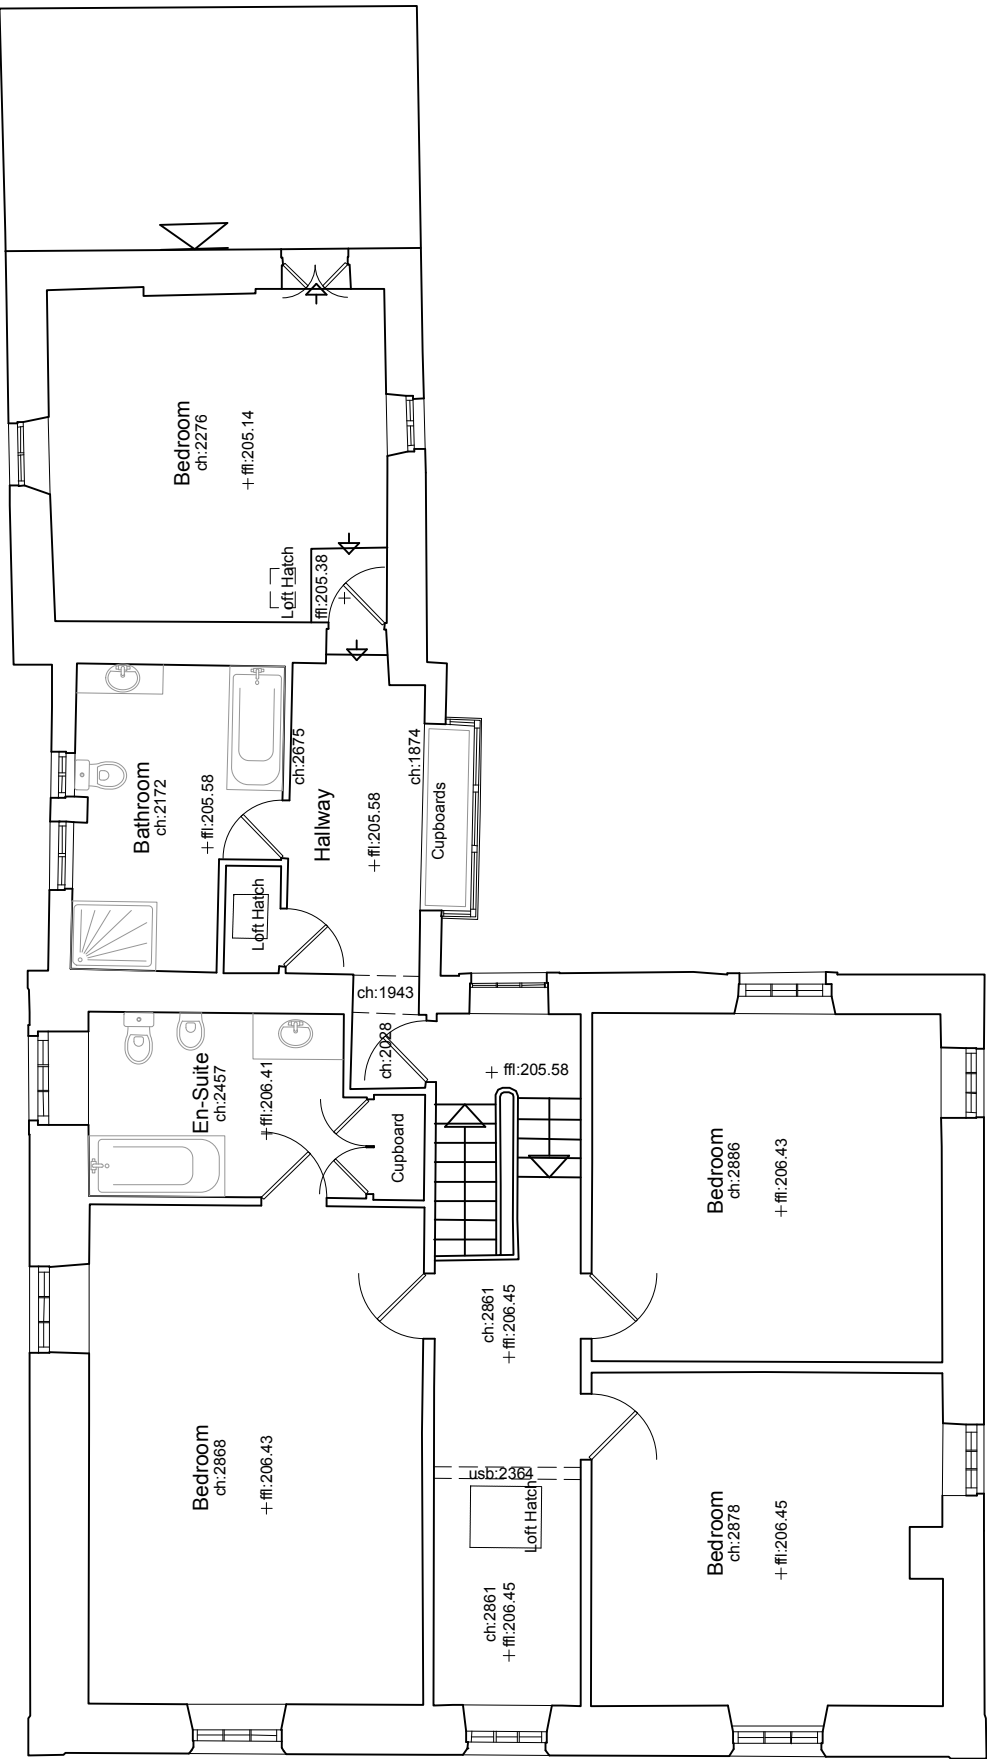
revision	date	note
A	04.05.21	lawful development certificate



A Lower Ground Floor Plan  
Scale: 1:100



B Ground Floor Plan  
Scale: 1:100




C First Floor Plan  
Scale: 1:100

ABBREVIATIONS

AB	Air Brick
BOL	Bollard
CH	Cable Height
ch:	Cieling Height
CL	Cover Level
EH	Eaves Height
fch:	False Cieling Height
ffl:	Finished Floor Level
GU	Gully
IC	Inspection Cover
MW	Monitoring Well
RH	Ridge/Roof Height
RWP	Rain Water Pipe
SP	Sign Post
SVP	Soil Vent Pipe
TL	Threshold Level
TP	Telegraph Pole
TW	Top of Wall
usb:	Under Side of Beam

NOTE  
All levels and coordinates relate to OSGB36(15) using GNSS data.

Levels defining edge of carriageway are observed at channel (bottom of kerb).

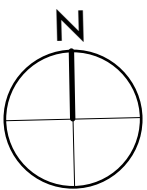

0m 10m scale

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project  
Martin Top Farm

project number  
19.75

drawing number

name  
floor plans

scale 1 to 100 @ A1  
date 14.10.20  
status information

revision  
A

Ex.02