




**Typical Section Thro' Filter Drain (Section A-A)**  
Scale 1:20

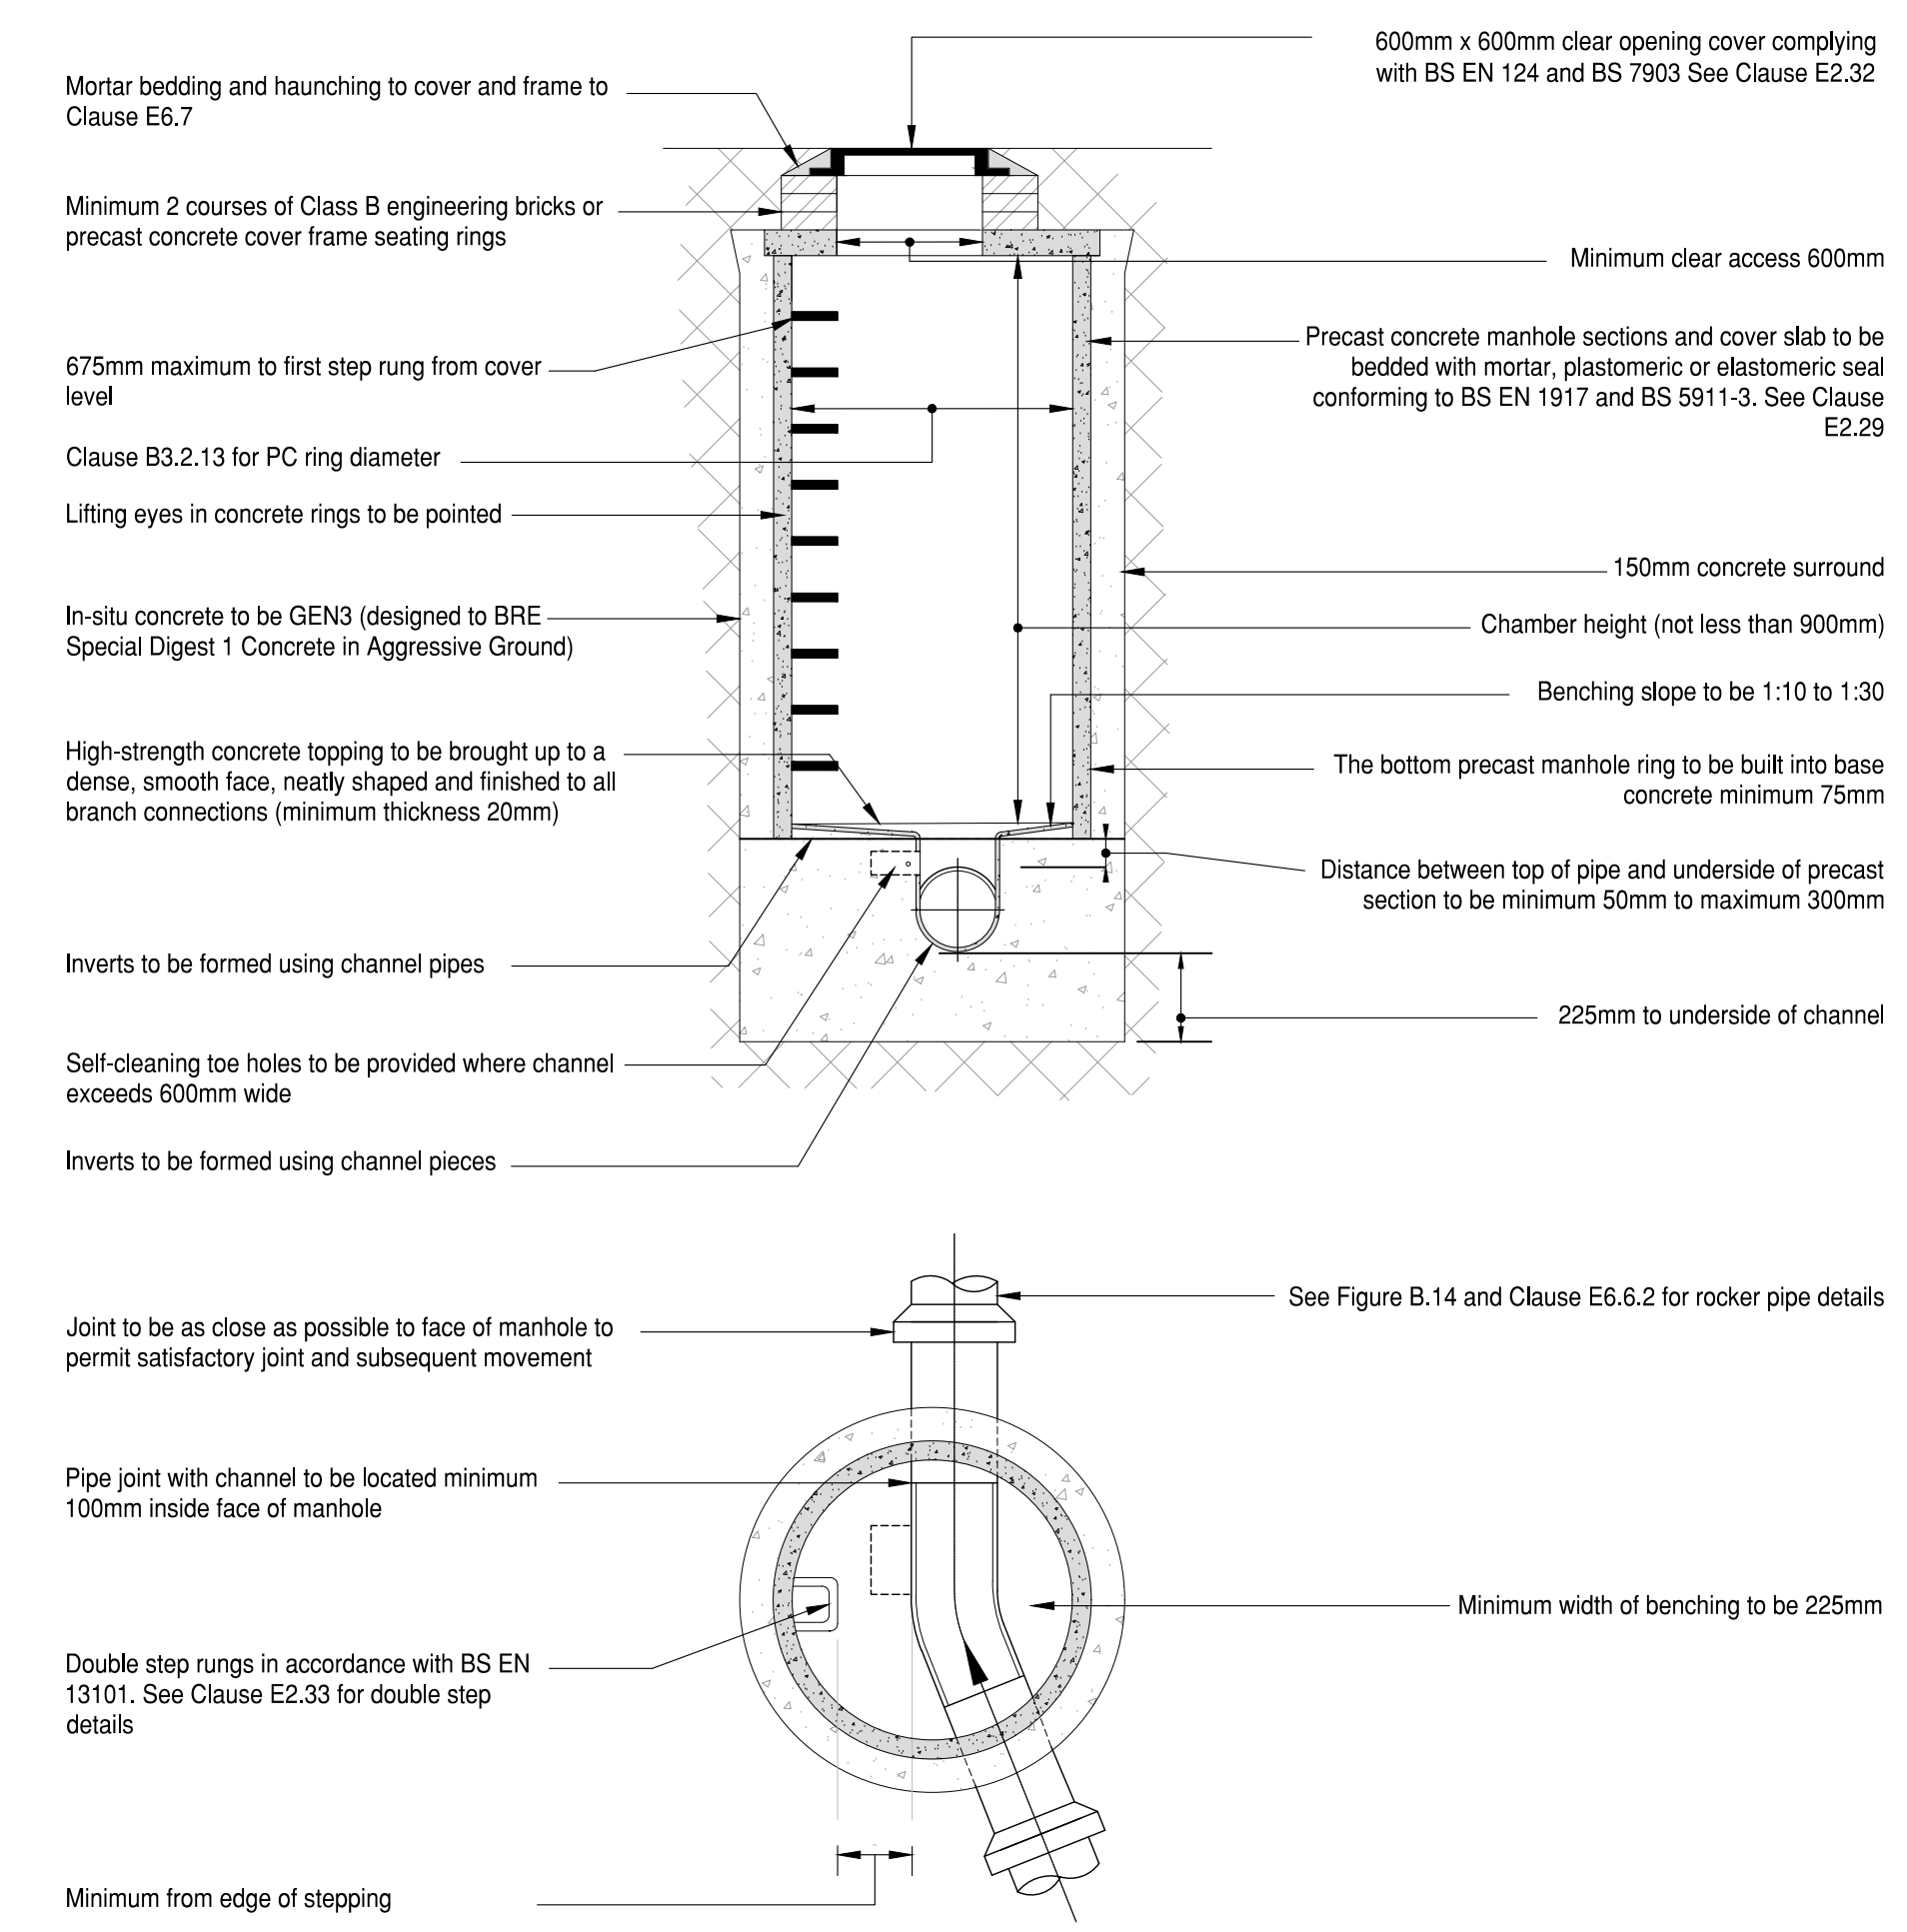


**Typical Manhole Detail (Max depth from cover to soffit of pipe 3.0m)**  
Scale 1:20

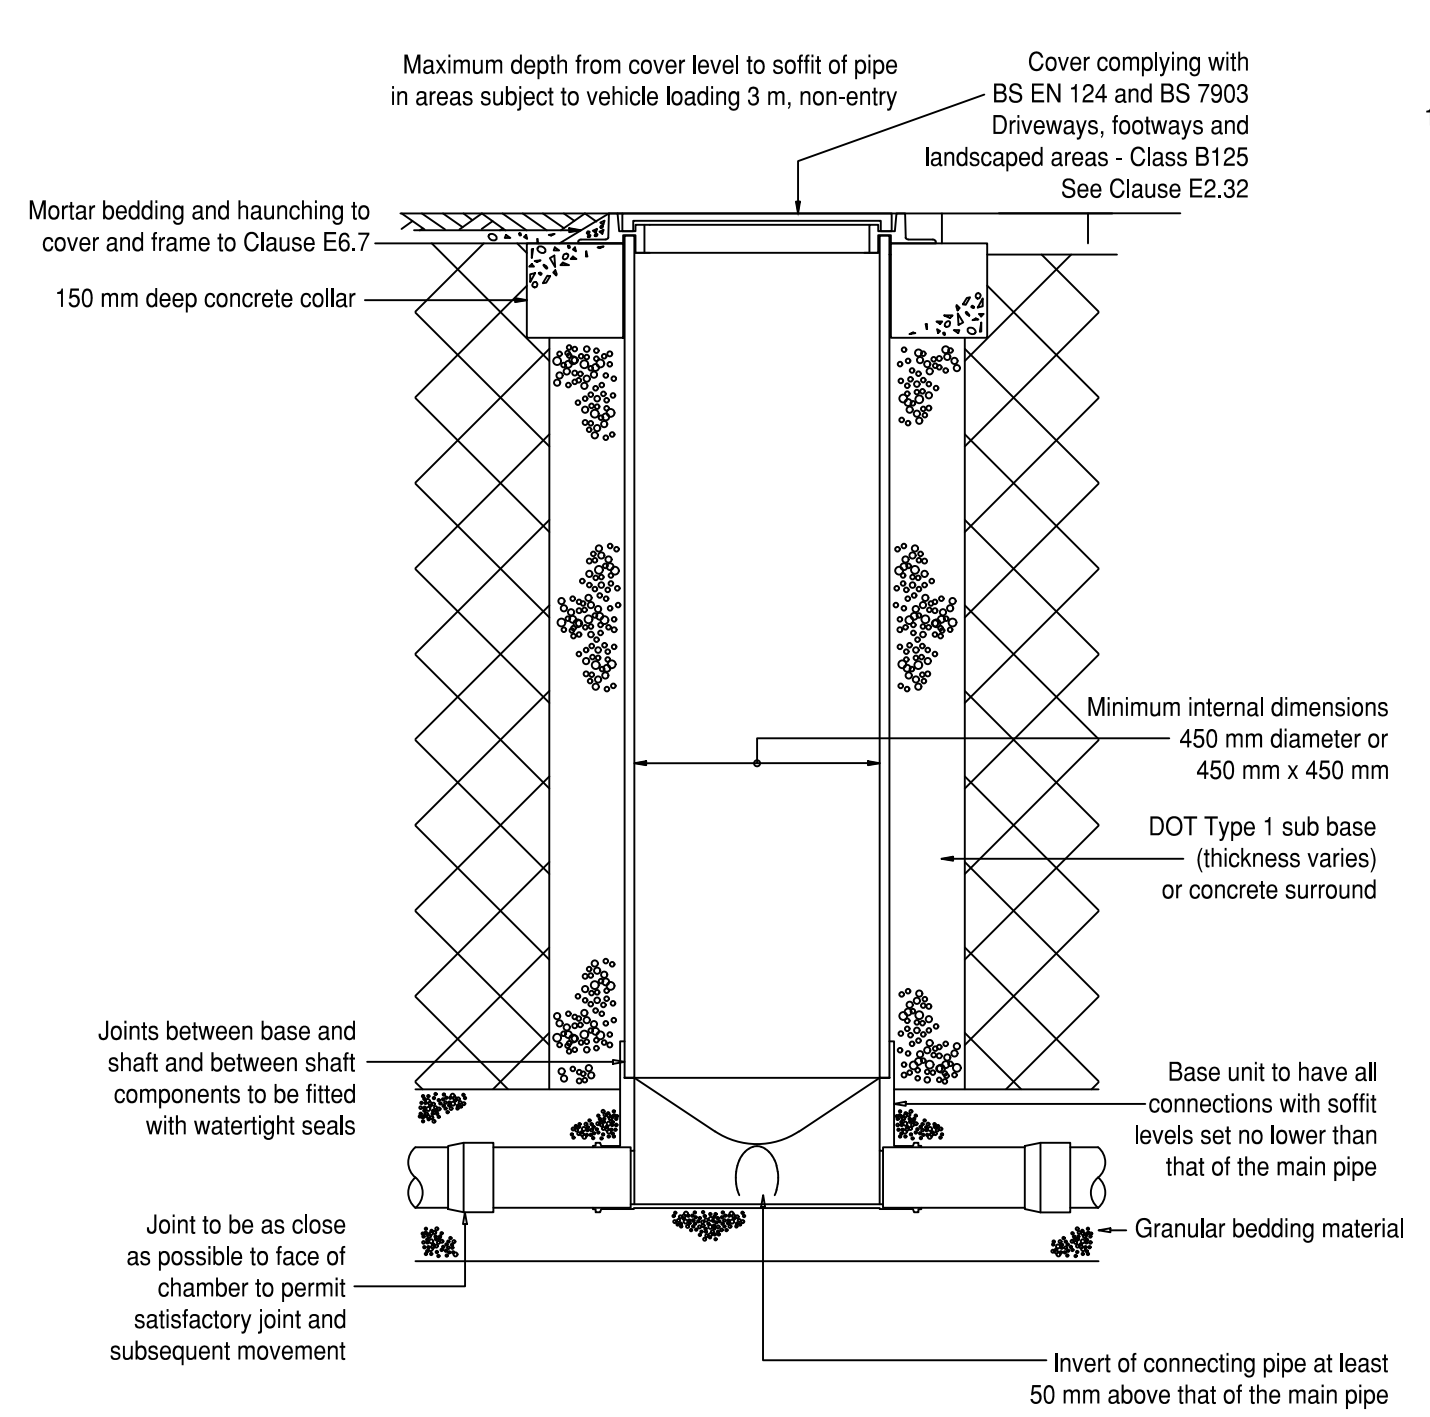


**Typical Inspection Chamber Detail (Fleccible Material Detail)**  
NTS

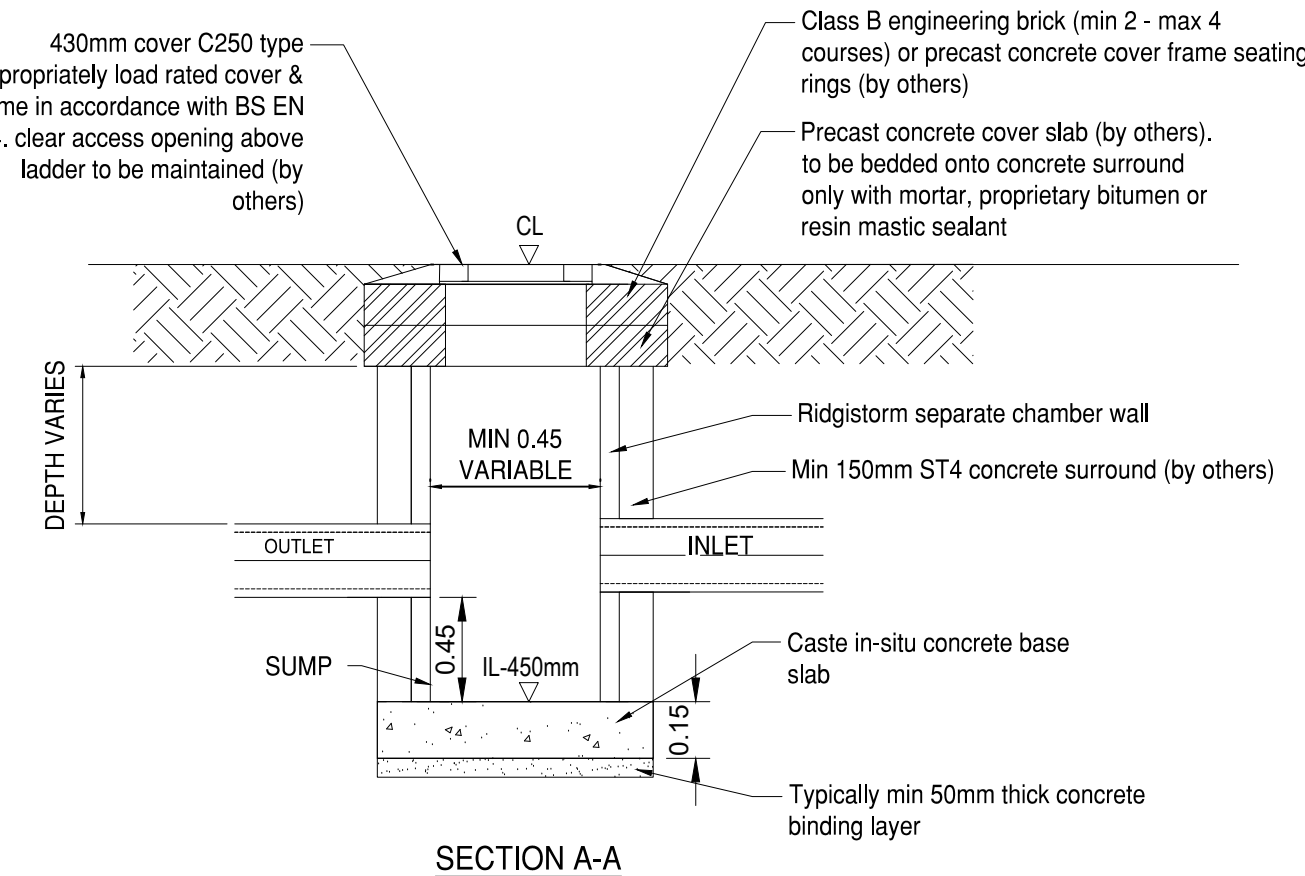


**SECTION A-A**

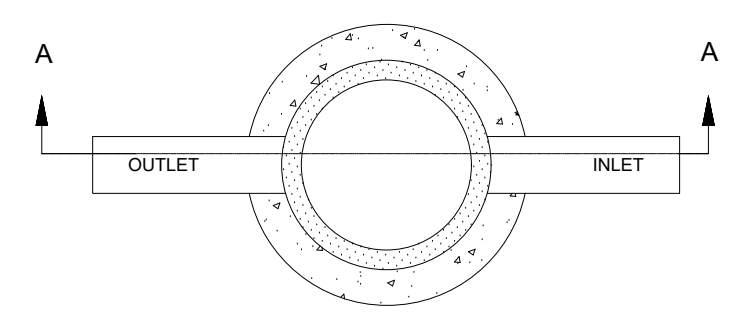


**PLAN**  
**Rigistorm Separate Catchpit**  
NTS

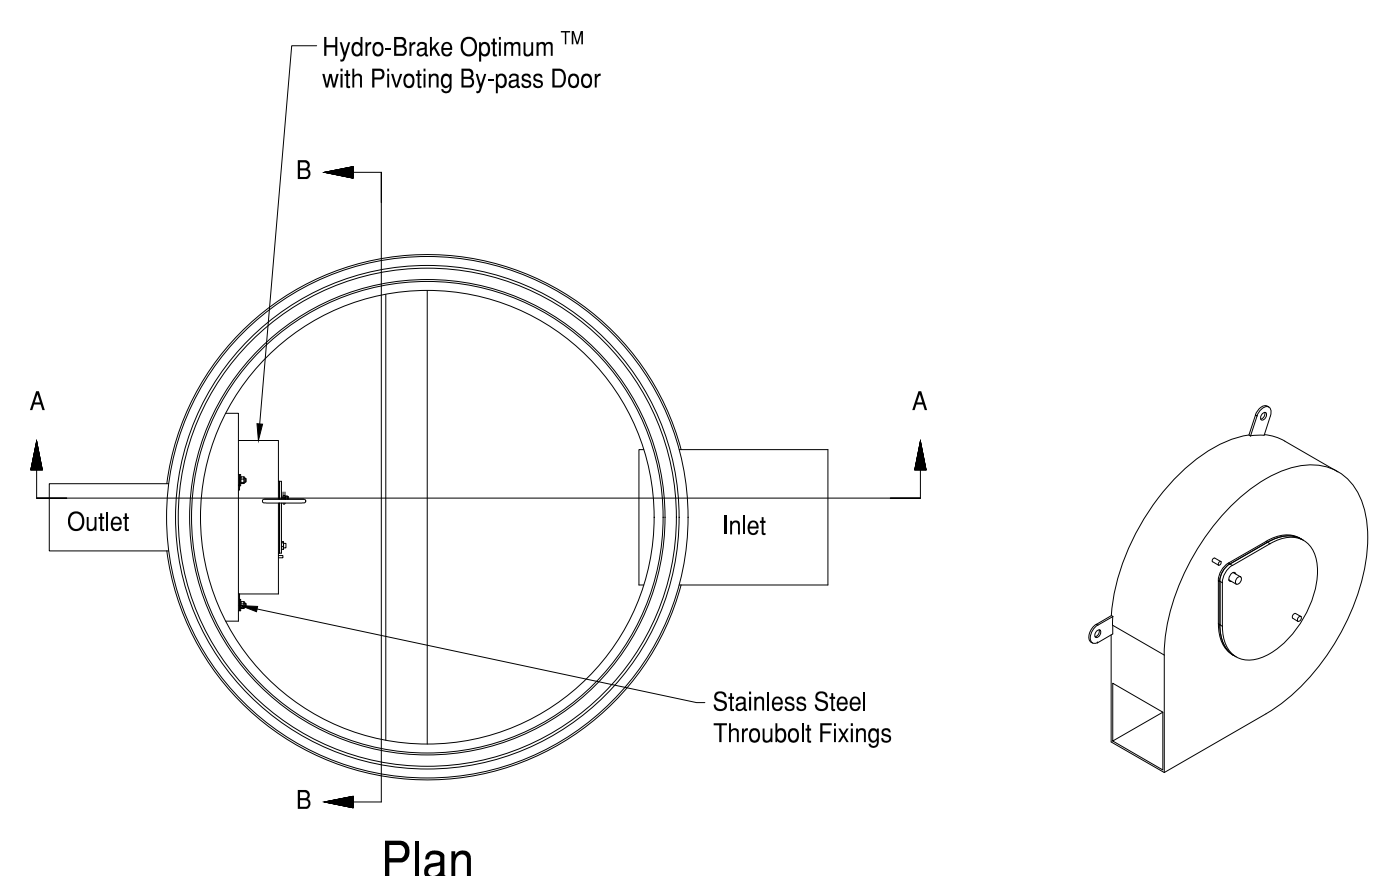


**Typical Hydrobrake Chamber Detail With Overflow Pipe**  
Scale 1:20

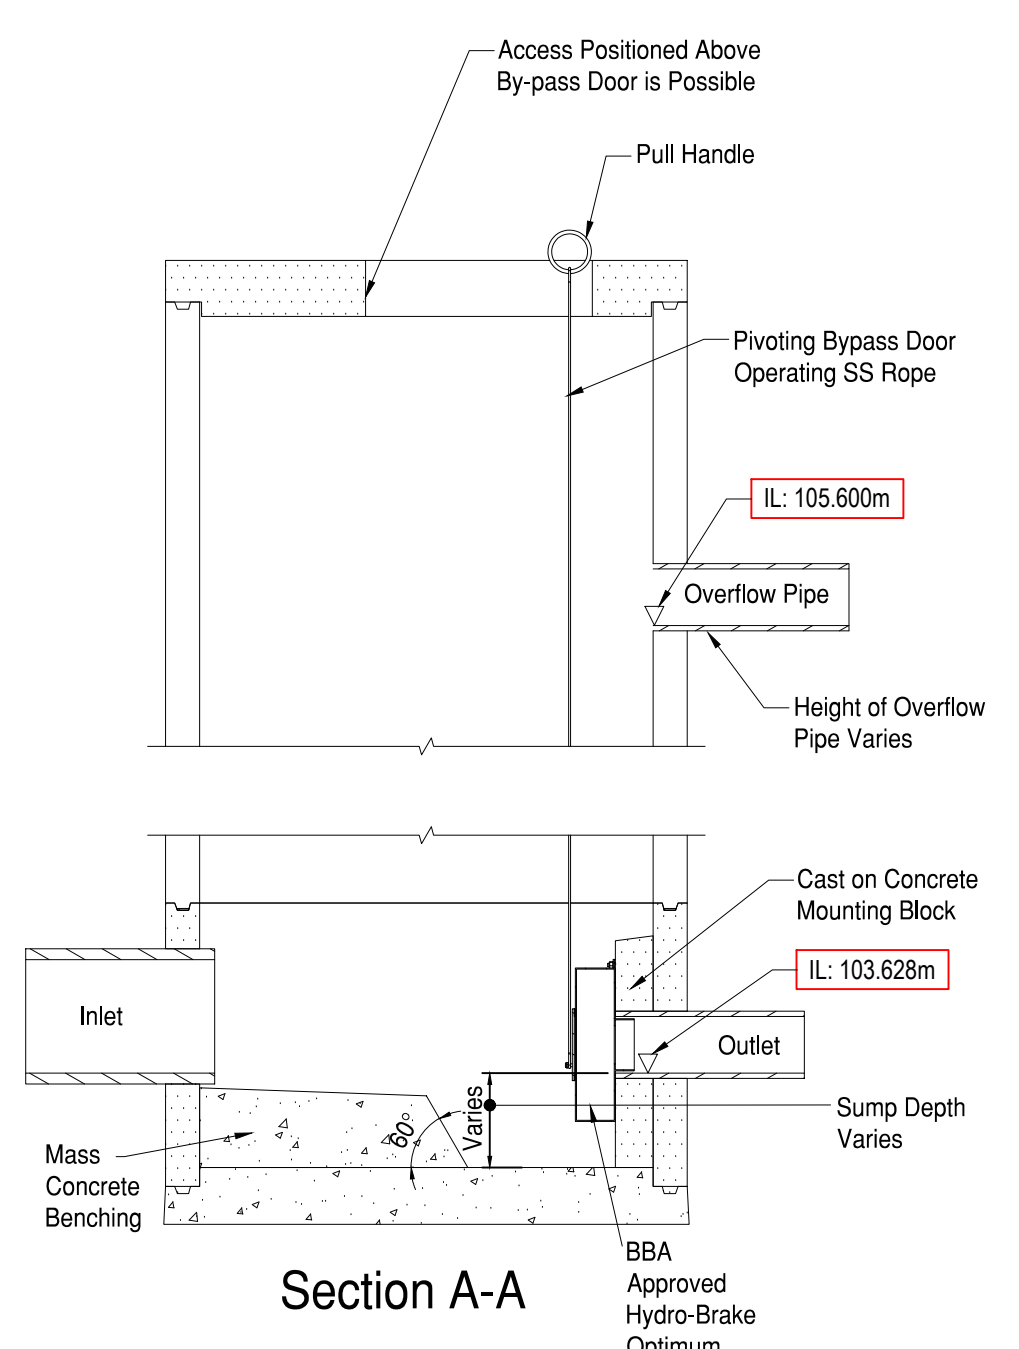

**Section A-A**

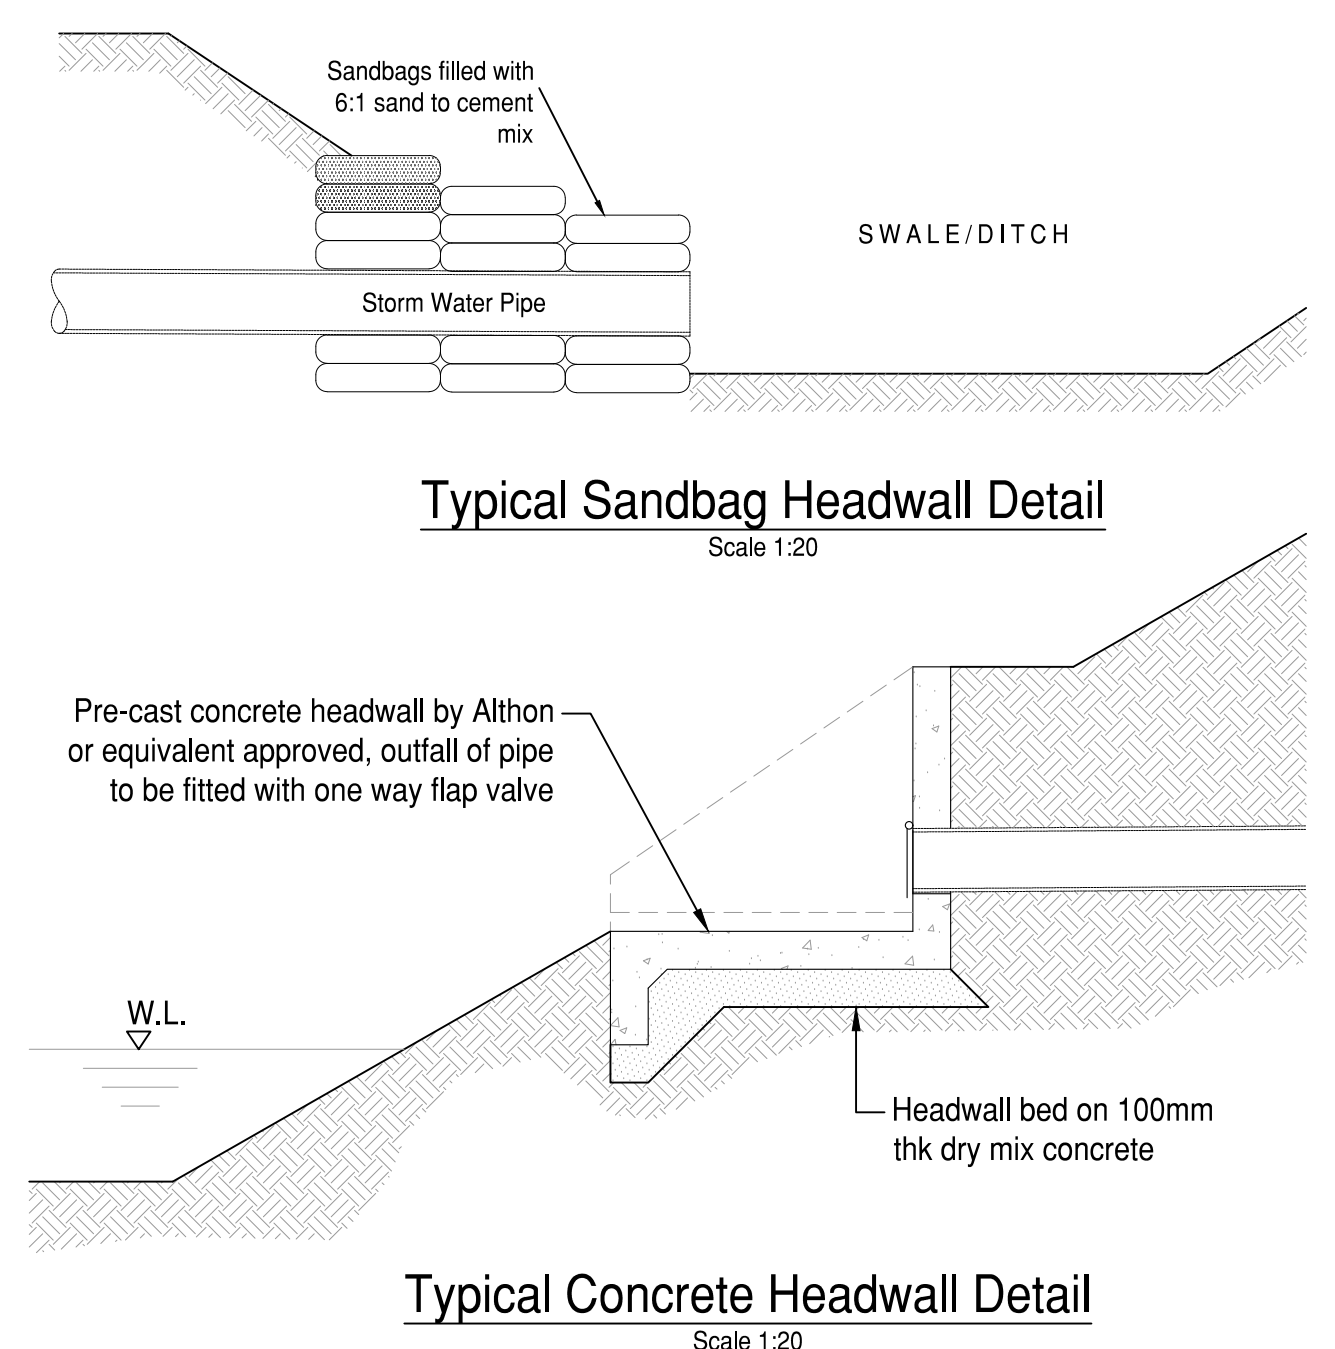

**Typical Concrete Headwall Detail**  
Scale 1:20

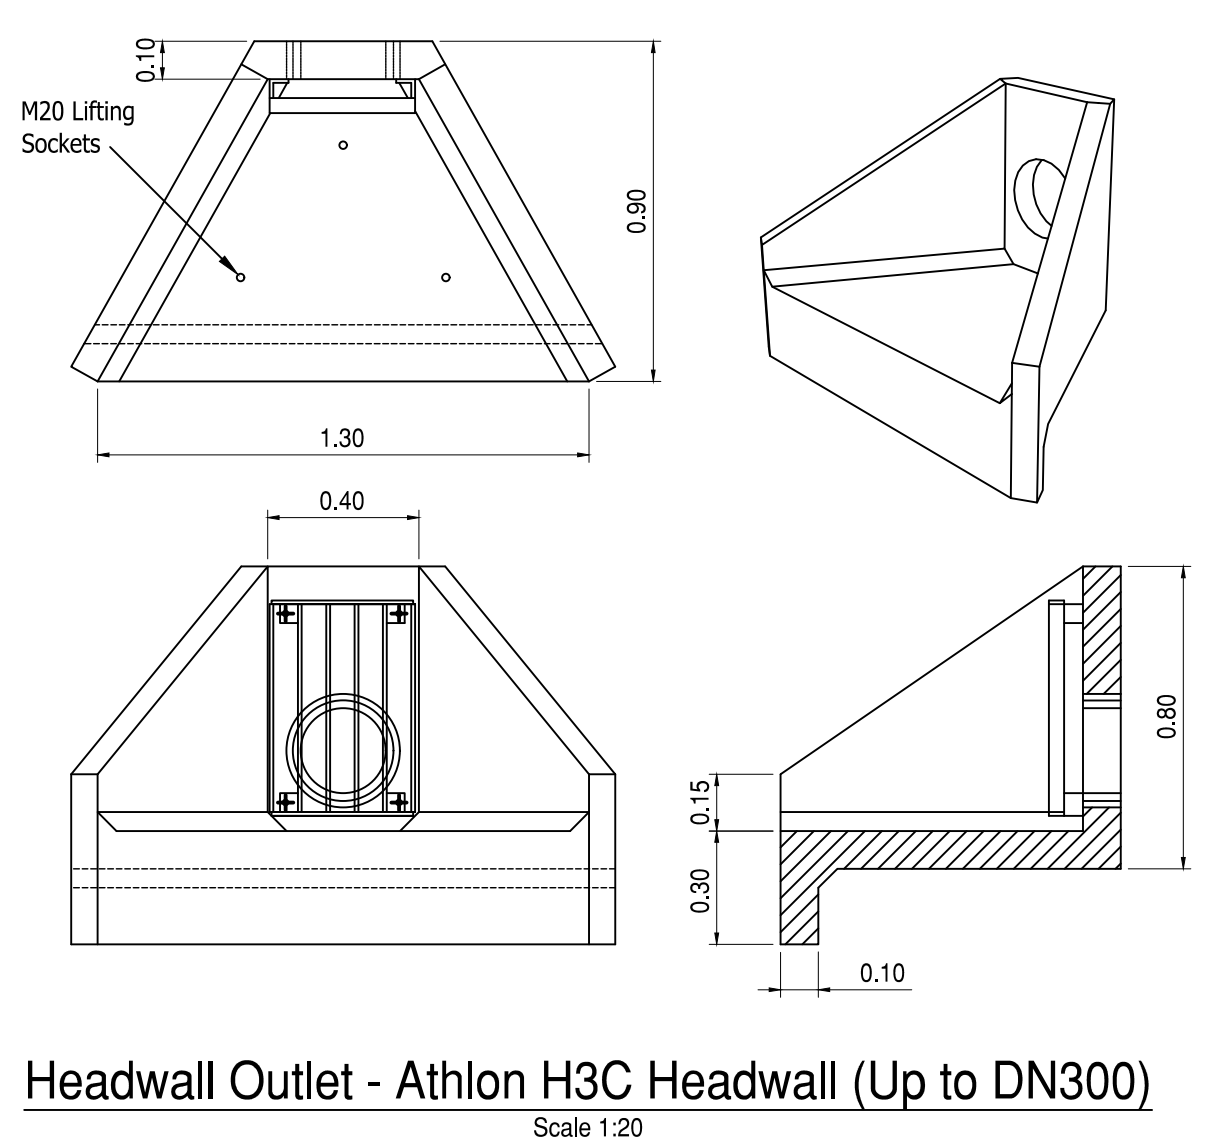

**Headwall Outlet - Athlon H3C Headwall (Up to DN300)**  
Scale 1:20

**Safety, Health & Environmental Information:**  
In addition to the hazards and risks normally associated with the types of work detailed on this drawing, please note the significant hazards identified by symbols below.

INDICATES A RESIDUAL RISK AS A WARNING

INDICATES A RESIDUAL RISK FOR INFORMATION and described below:

**Construction/Maintenance/Cleaning/Demolition**  
Refer to Drawing:

- General Notes:**
- Do not scale from this drawing.
  - All dimensions are in millimetres (mm), all levels in metres (m) unless noted otherwise.
  - Discrepancies or omissions are to be reported to the Engineer prior to work commencing.
  - Materials and workmanship are to comply in all respects with current British Standard Specifications, Codes of Practice, and Building Regulations Approved Documents.
  - The copyright of this drawing is vested in the Engineer and must not be copied or reproduced without written consent.
  - The Contractor is to check and verify all building and site dimensions, levels and sewer invert levels at connection points before work commences.
  - This drawing is to be read in conjunction with all relevant specifications and drawings issued by the Engineer, Architect and other Specialists.
  - For drainage plans refer to drawing:  
- RCF-BML-ERD-ZZ-DR-C-0550 Combined Drainage Layout

**PRELIMINARY DRAWING**  
This drawing is not to be used for construction

P02	DH	AM	2/07/23	Details Updated
P01	RA	GM	13/04/23	Preliminary
Rev	By	Chkd	Date	Description

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Project  
**Cow Shed**  
Elmridge Lane, Preston,  
PR3 2NY

Drawing  
**Drainage Details**  
Sheet 2 of 2

Drawn by	Date
Checked by RA/GM	Date 05/04/2023
Drawing No.	Revision
<b>CSH-BML-XX-XX-DR-C-0502</b>	<b>P02</b>
BML Job No.	
<b>1000-05</b>	
Drawing Scale at A1: NTS	
CAD Filename:	