


Safety, Health & Environmental Information:

In addition to the hazards and risks normally associated with the types of work detailed on this drawing, please note the significant hazards identified by symbols below.

 INDICATES A RESIDUAL RISK AS A WARNING


 INDICATES A RESIDUAL RISK FOR INFORMATION

and described below:


Construction/Maintenance/Cleaning/Demolition
Refer to Drawing:

General Notes:

1. Do not scale from this drawing.
2. All dimensions are in millimetres (mm), all levels in metres (m) unless noted otherwise.
3. Discrepancies or omissions are to be reported to the Engineer prior to work commencing.
4. Materials and workmanship are to comply in all respects with current British Standard Specifications, Codes of Practice, and Building Regulations Approved Documents.
5. The copyright of this drawing is vested in the Engineer and must not be copied or reproduced without written consent.
6. The Contractor is to check and verify all building and site dimensions, levels and sewer invert levels at connection points before work commences.
7. This drawing is to be read in conjunction with all relevant specifications and drawings issued by the Engineer, Architect and other Specialists.

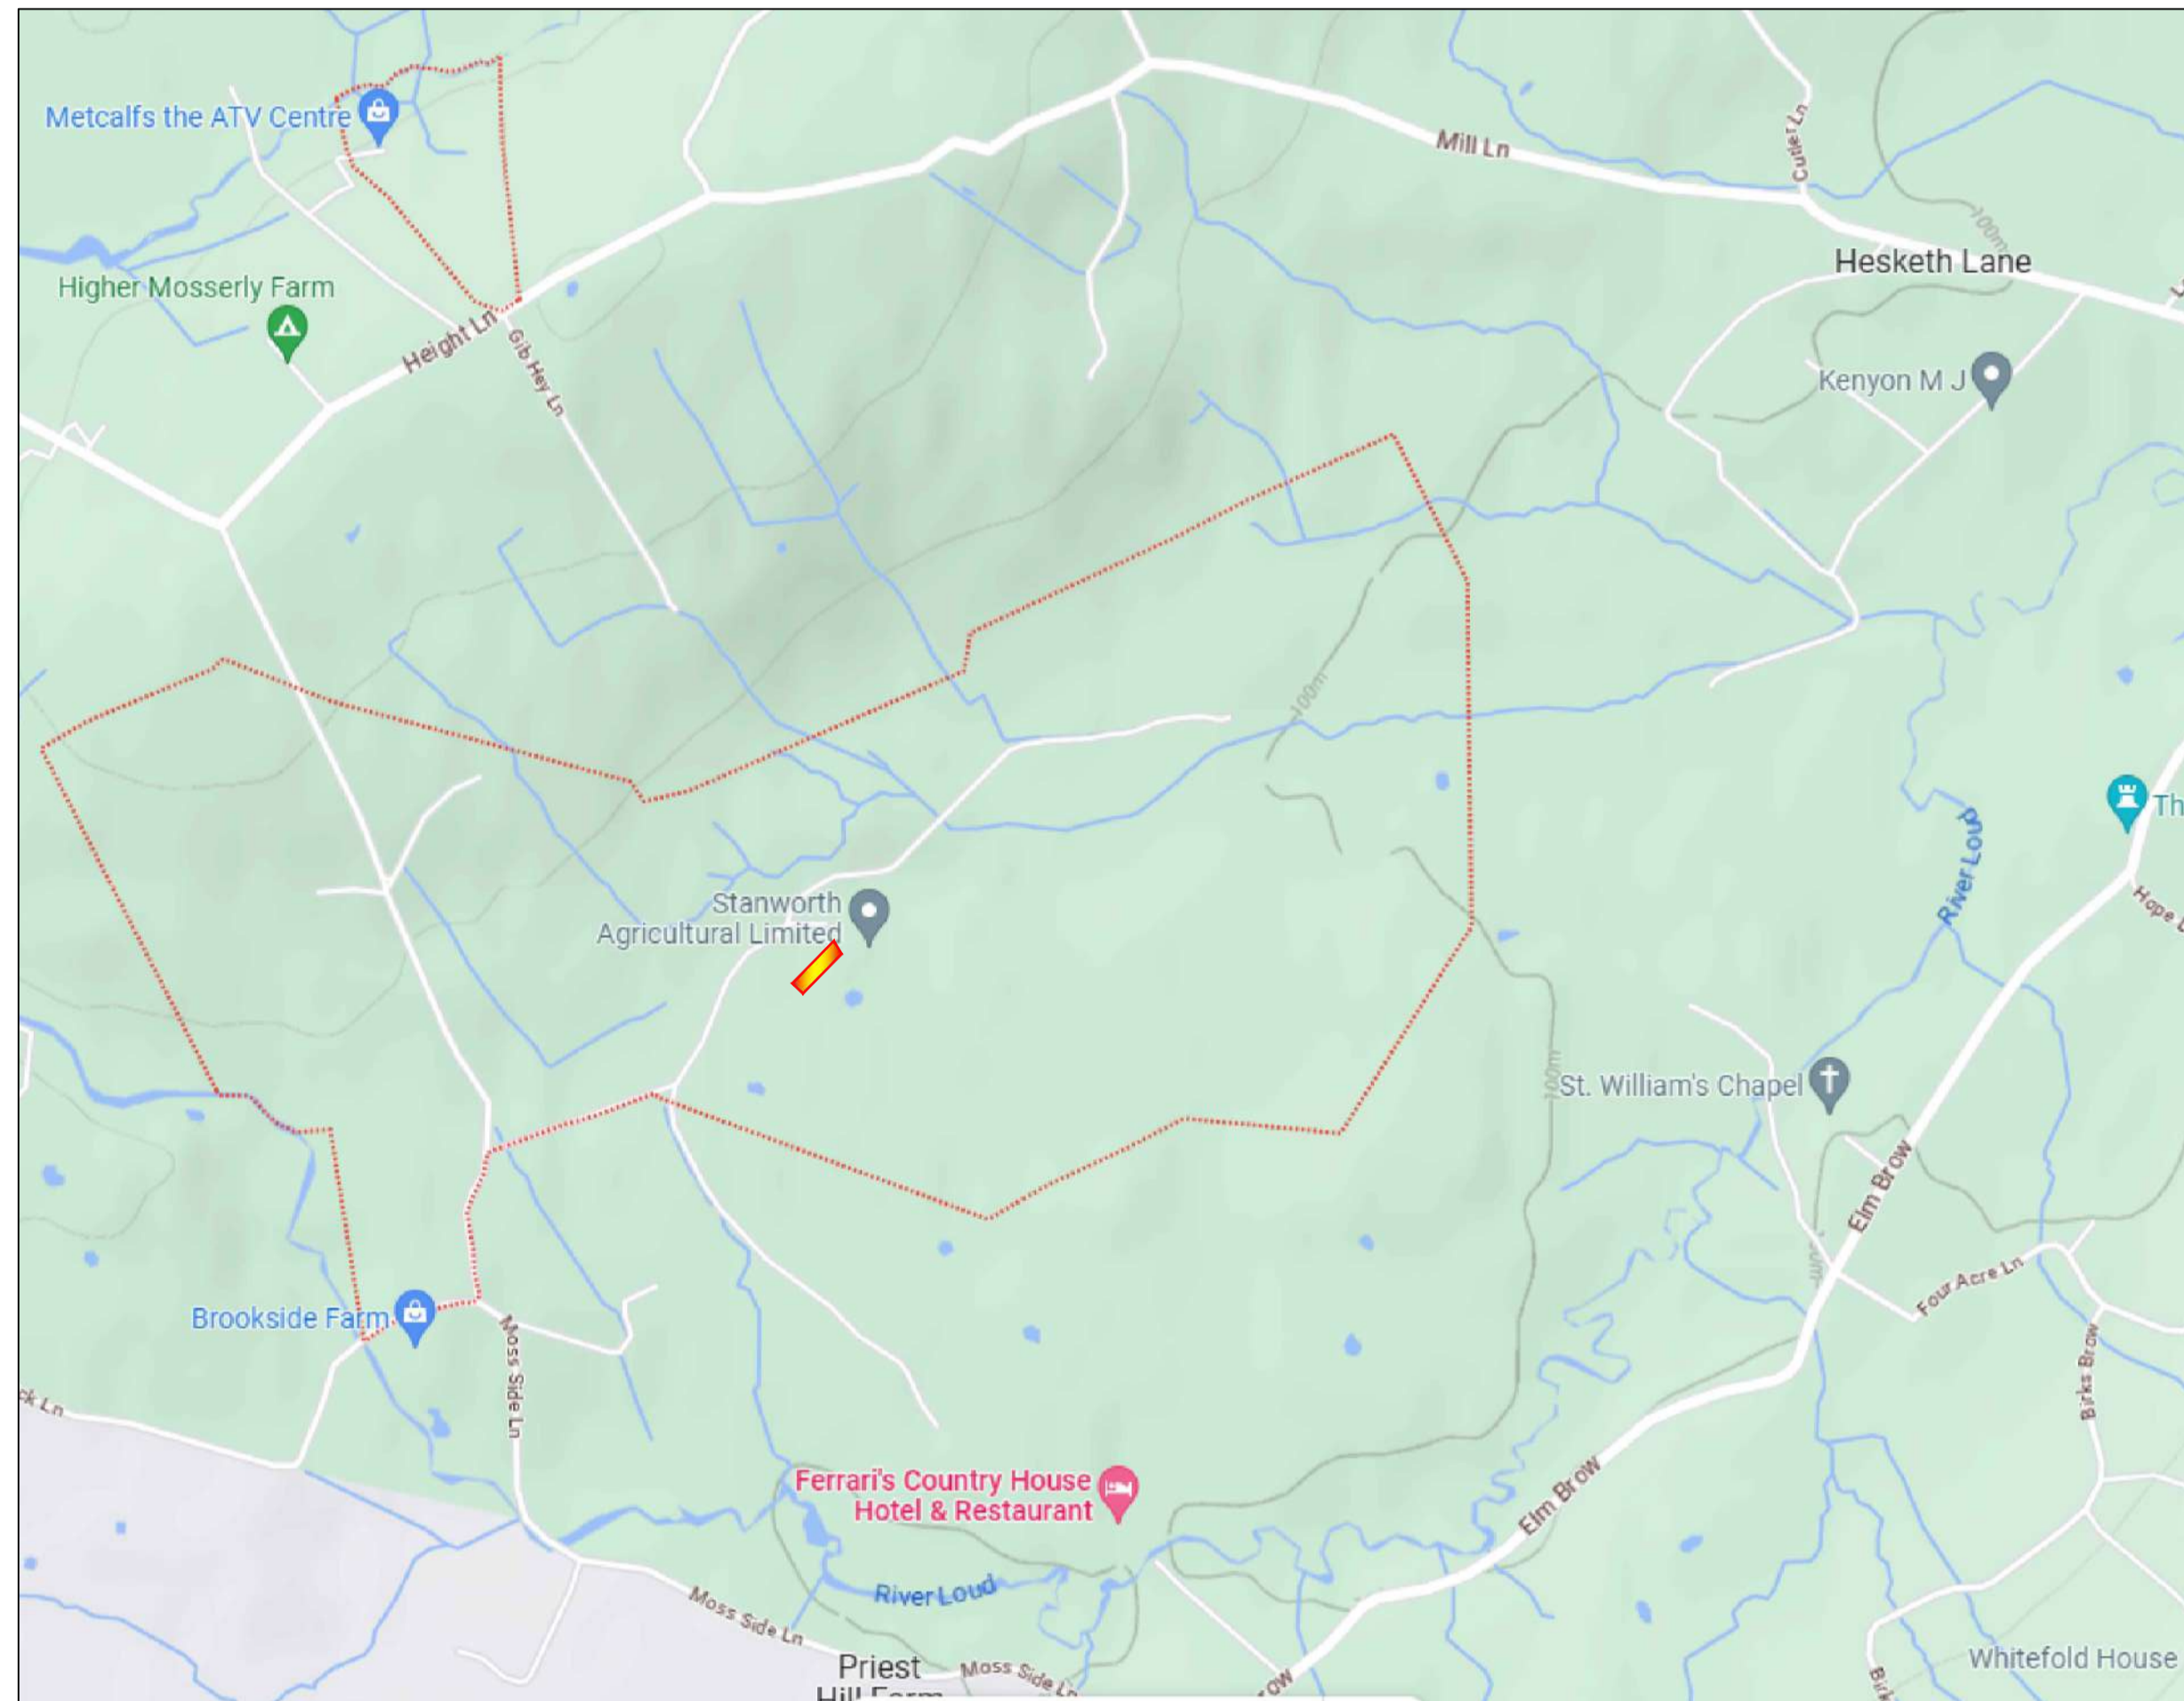

Location Plan

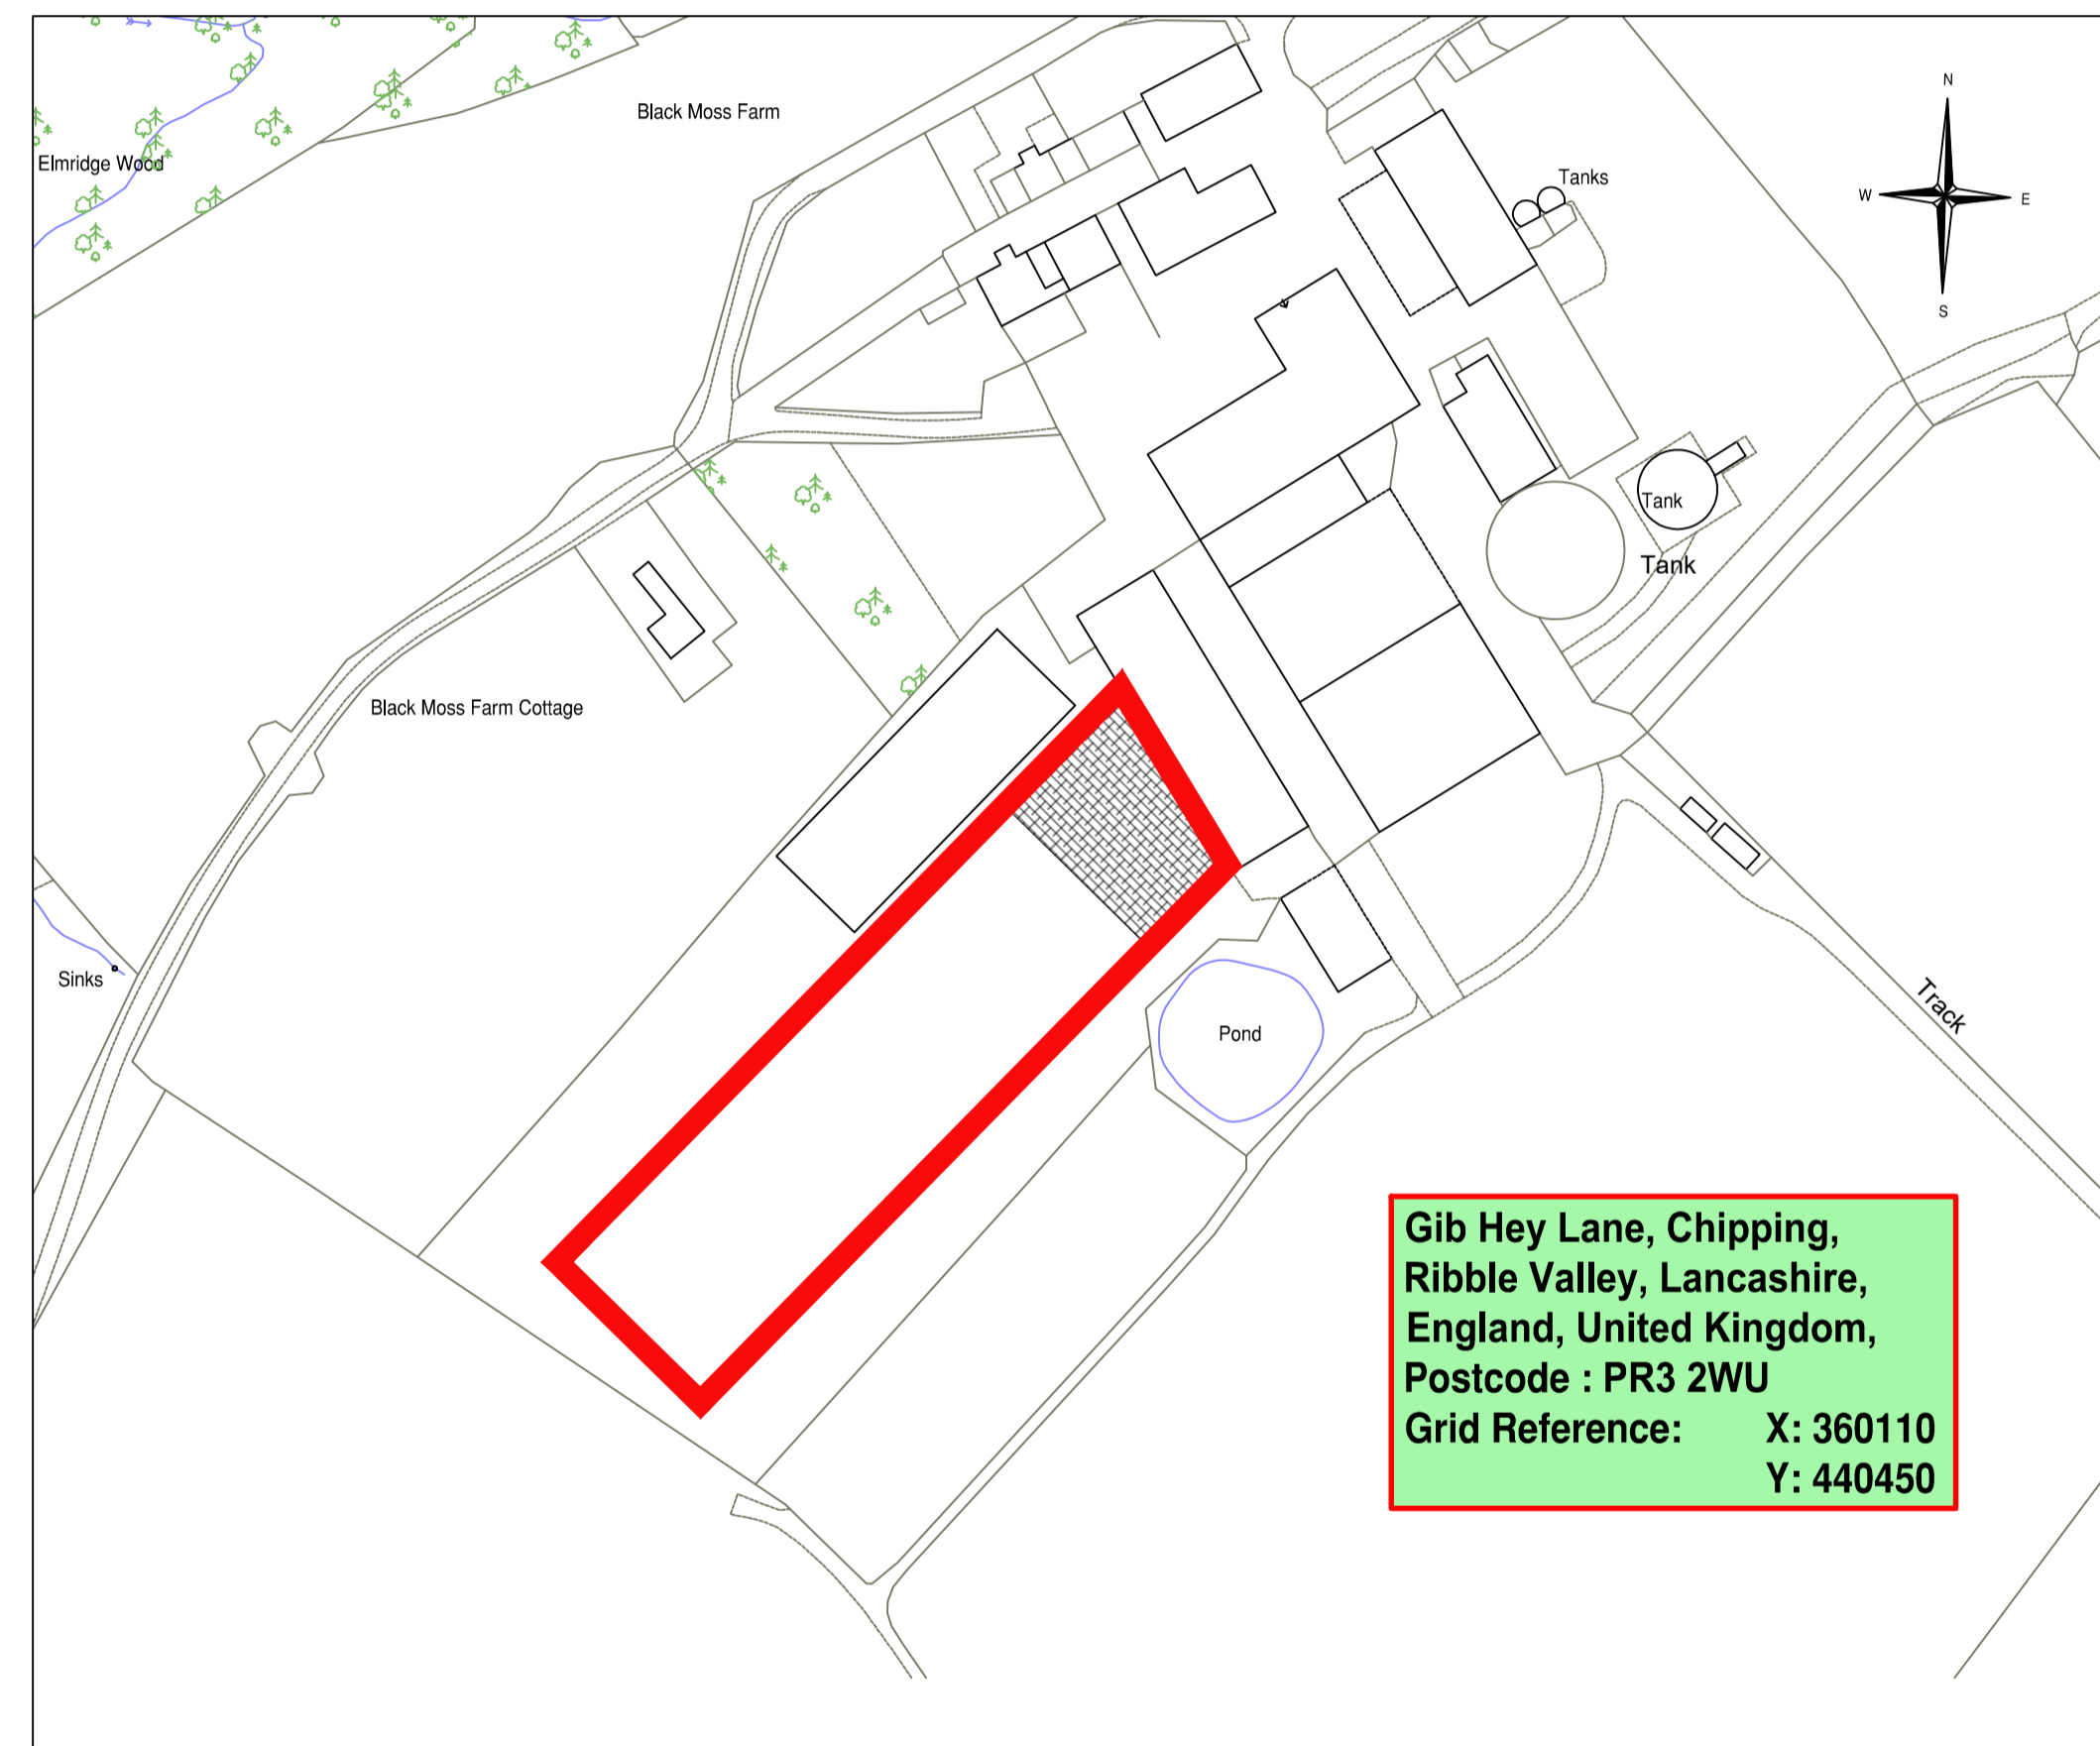

**Gib Hey Lane, Chipping,
Ribbles Valley, Lancashire,
England, United Kingdom,
Postcode : PR3 2WU
Grid Reference: X: 360110
Y: 440450**

Site Plan
Scale 1:1250

P01	DH/AM	19/07/2023	For Discussion
Rev	By / Chk'd	Date	Description

PRELIMINARY DRAWING
This drawing is not to be used for construction



BarnsleyMarshall Limited
1 Birch Court
Blackpole East
Worcester
WR3 6SG

Tel: 01905 330550
Email: design@barnsleymarshall.co.uk
Web: www.barnsleymarshall.co.uk

Project
**Cow Shed
Elmridge Lane, Preston,
PR3 2NY**

Drawing
Site Location Plan

By/Chk'd	DH/AM	Date	18/07/2023
Drawing No.	CSH-BML-XX-XX-DR-C-0100		Revision P01
BML Job No.	1000-05		Status -

Drawing Scale at A1: As Shown

CAD Filename: Y:\projects\100-05 Cow Shed\BarnsleyMarshall\CSH-BML-XX-XX-DR-C-0100.rvt