


**Important Note:**  
It is the contractor's responsibility to check all dimensions on site and acquaint himself with the work involved. Any discrepancies to be reported to the agent for clarification prior to starting work.



1 Proposed Front Elevation  
Scale 1:100



3 Proposed Side Elevation  
Scale 1:100

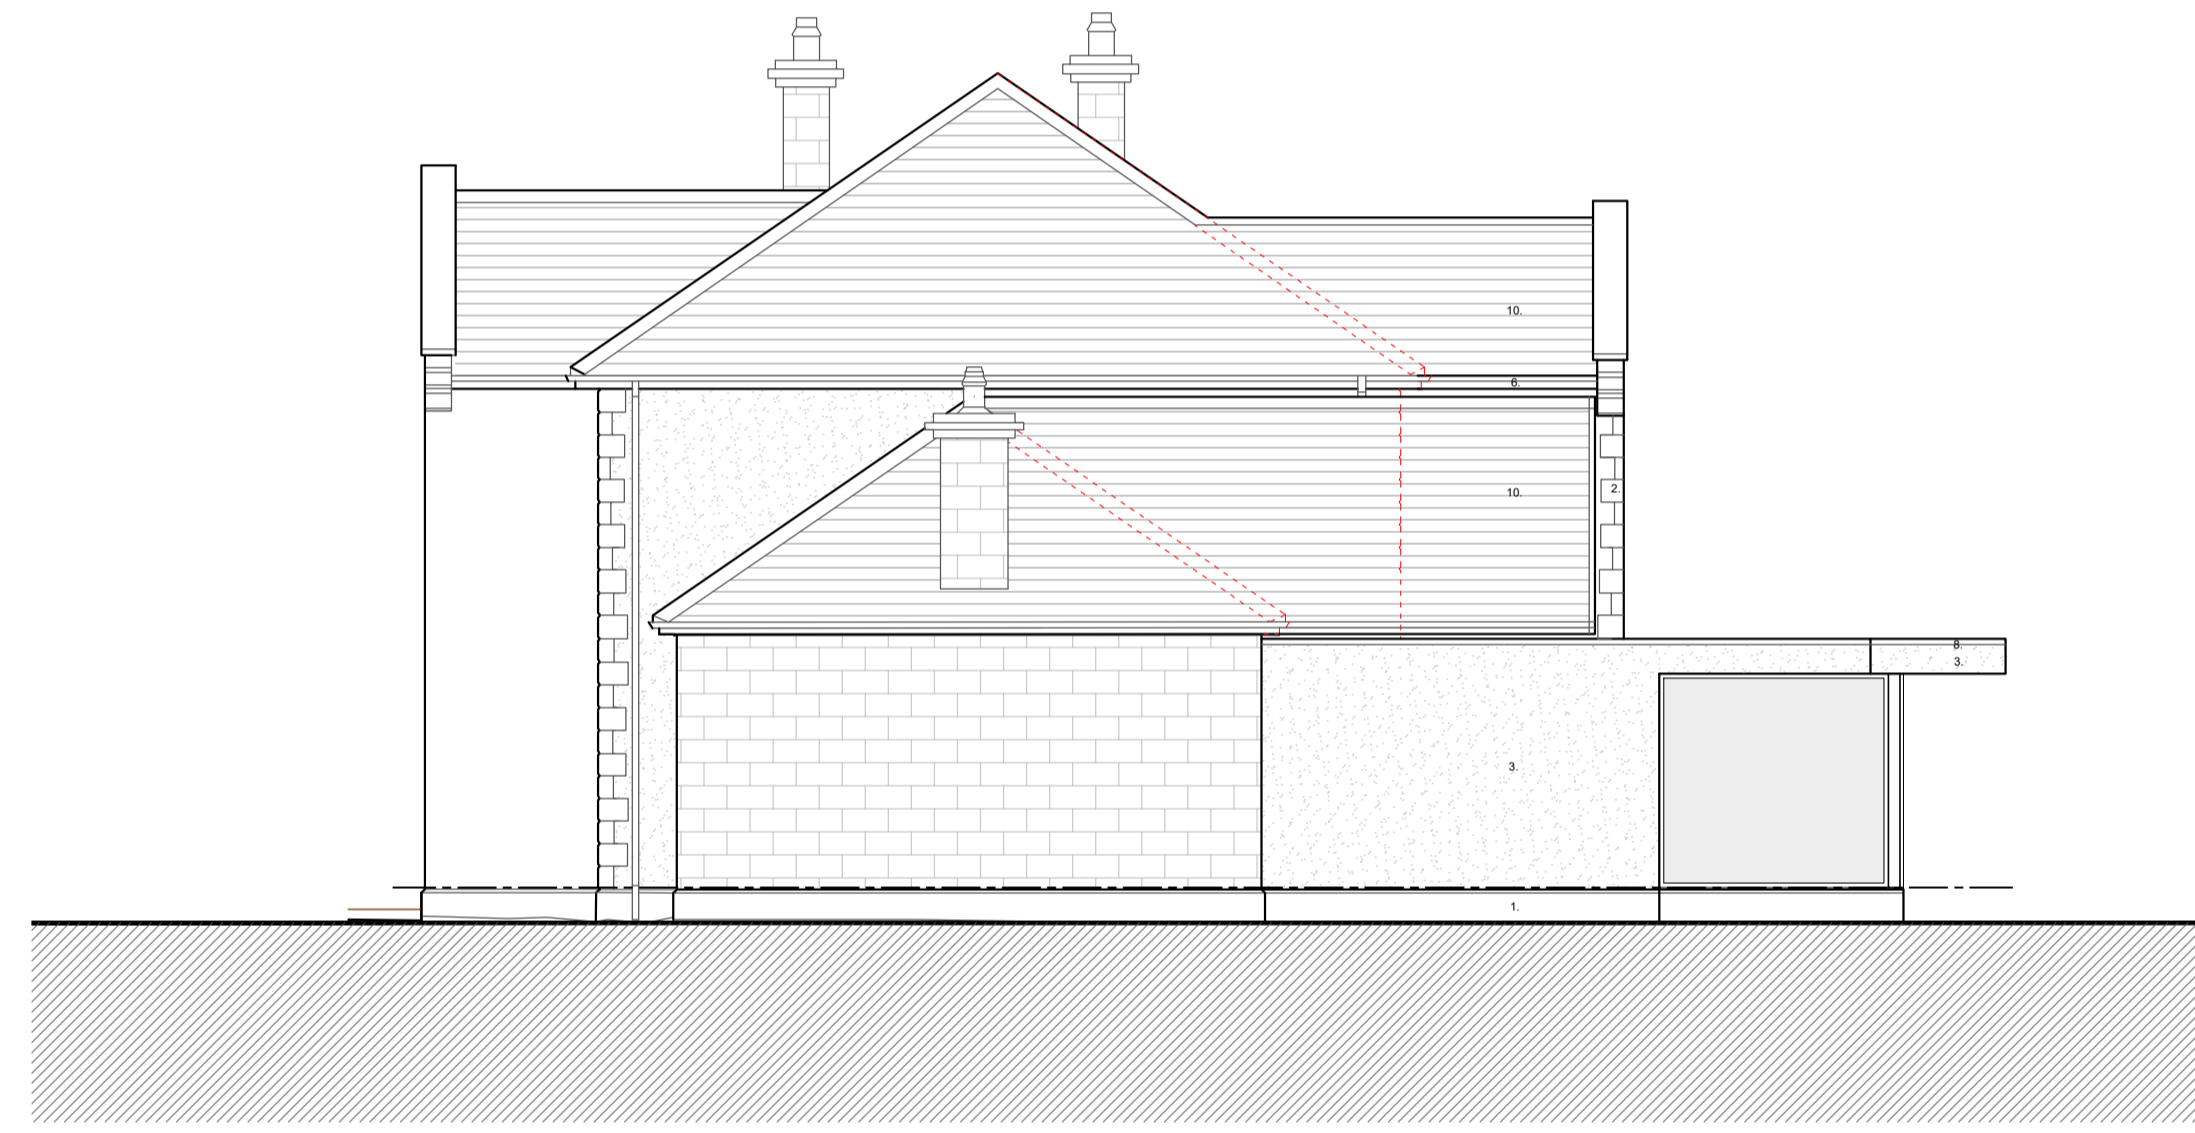

4 Proposed Side Elevation  
Scale 1:100

- Proposed Materials:**
1. Ashlar stone - To match existing.
  2. Ashlar stone quoins to match existing.
  3. Render finish to match existing.
  4. Slate Cladding to match existing Roof.
  5. Timber cladding - Cedar wood.
  6. Fascias, Soffit & guttering to match existing.
  7. Aluminum Glazing frame - to client's choice.
  8. Pressed metal edge roofing trim.
  9. 1.1m High glazed balustrading.
  10. Roof slates to match existing.



2 Proposed Rear Elevation  
Scale 1:100

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**Proposed Elevations**

Rev.	Date	Description
F	26.08.2025	Rear & Side elevations amended to match internal adjustments.
G	02.09.2025	Patio Door openings indicated.
H	20.10.2025	Proposed materials indicated.
J	10.11.2025	Rear canopy projection & Link omitted for Permitted Development.

**DO NOT SCALE:** Use figured dimensions only. Contractor is to check all dimensions before commencement of works. It is the contractor's responsibility to report any inconsistencies on this drawing, or between drawings, to the Architect and to request clarification and instruction before proceeding. This drawing must only be used for the purpose for which it is supplied. This drawing is the copyright of Areeba Architecture Ltd and may not be reproduced in any form whatsoever without prior express written consent.



**Proposed Elevations**

Client: Mr S Dajal	Drawing No: BB355- 110-J
Project: Woodfold Park Stud Woodfold Park, Mellor, Blackburn, BB2 7QA	Purpose of Issue: Planning
Scale: 1:100 @ A1	Date: Nov 2025