
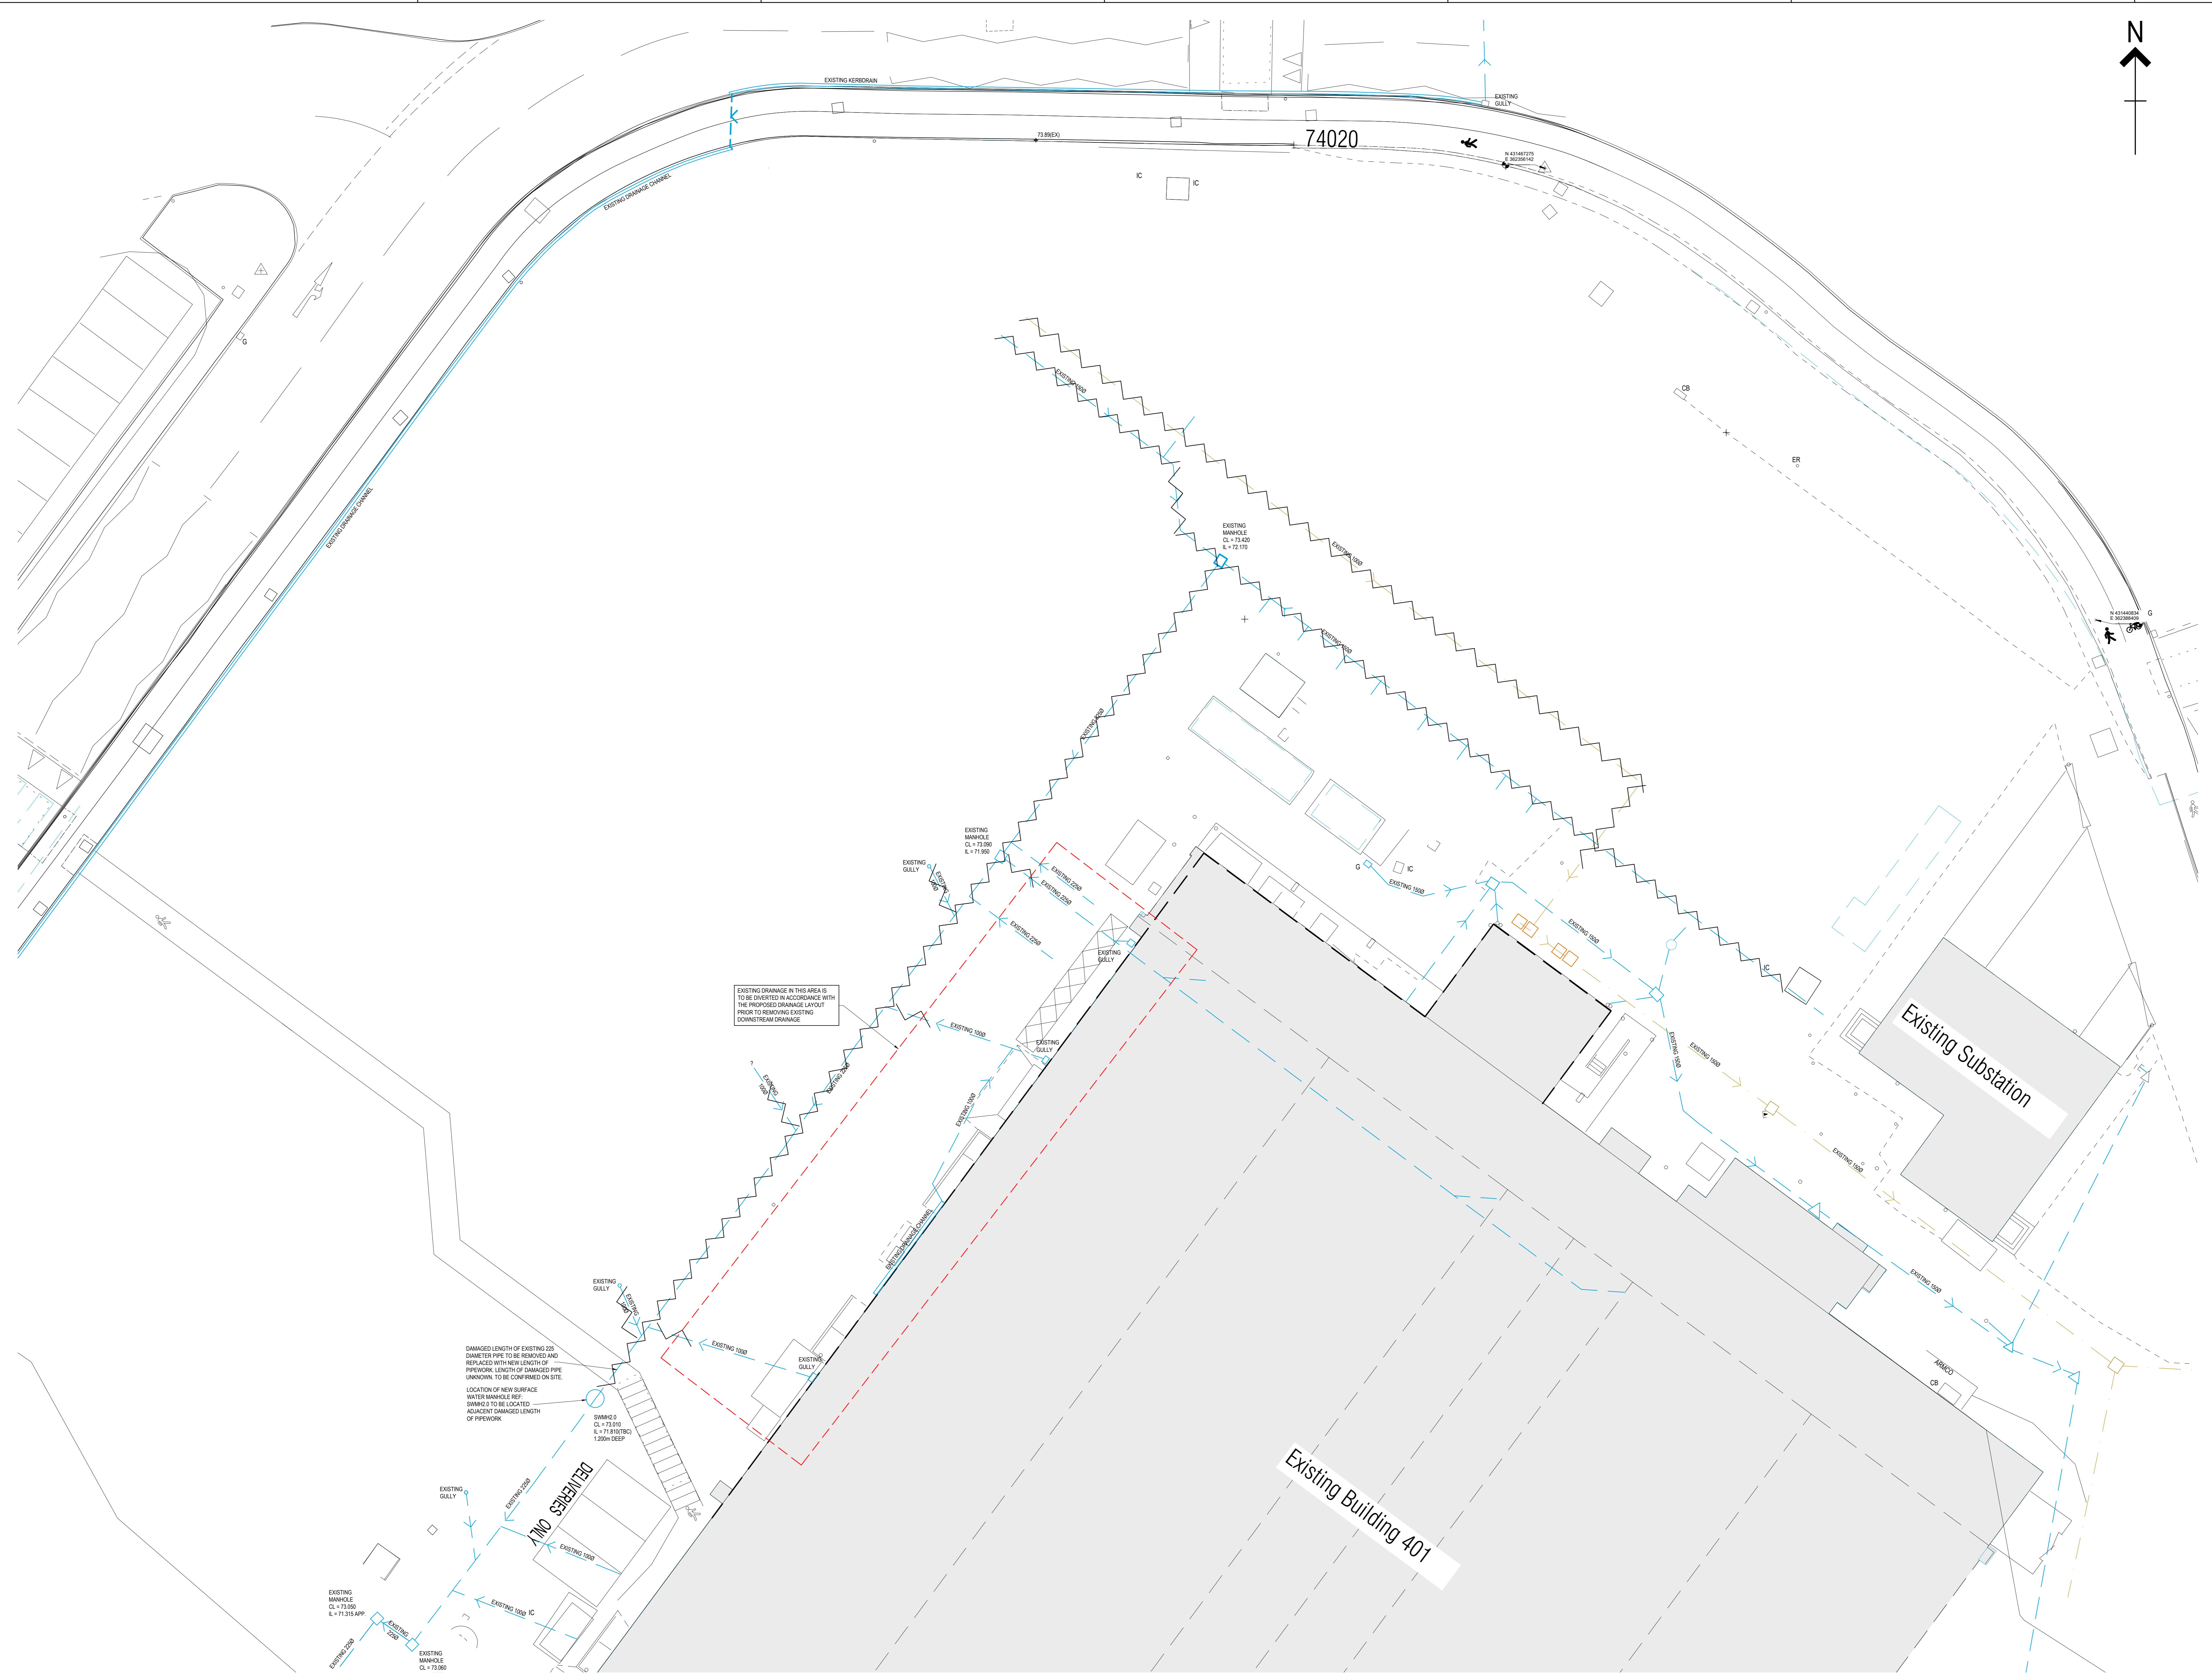


**GENERAL NOTES**

1. THIS DRAWING IS TO BE READ IN CONJUNCTION WITH ALL RELEVANT SLEATER & WATSON LLP DRAWINGS AND SPECIFICATIONS ALONG WITH ALL ARCHITECTURAL AND MECHANICAL & ELECTRICAL ENGINEERING CONTRACT DOCUMENTS, WHERE DWT, TRIT, TRIT OR TRIT FILES ARE SUPPLIED. THESE ARE FOR COLLABORATION WITH OTHER CONSULTANTS' INFORMATION AND SHOULD NOT BE USED FOR CONSTRUCTION PURPOSES BY THE CONTRACTOR, SUB-CONTRACTORS OR CLIENT. ONLY THE INFORMATION PROVIDED IN HARD COPY OR PDF FORMAT DRAWINGS IS TO BE RELED UPON FOR ACCURACY.
2. ALL LEVELS ARE SHOWN IN METRES AND RELATE TO ORDNANCE DATUM.

**DRAINAGE KEY**

EXISTING XXXX	EXISTING FOUL WATER DRAIN (PIPE DIAMETER)
EXISTING XXXX	EXISTING FOUL WATER DRAIN TO BE REMOVED
EXISTING XXXX	EXISTING SURFACE WATER DRAIN (PIPE DIAMETER)
EXISTING XXXX	EXISTING SURFACE WATER DRAIN TO BE REMOVED
○	EXISTING FOUL WATER MANHOLE
●	EXISTING SURFACE WATER MANHOLE
G	EXISTING GULLY

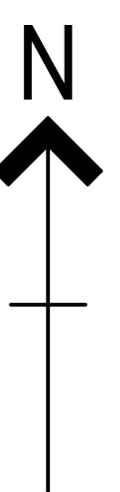

EXISTING DRAINAGE IN THIS AREA IS TO BE DIVERTED IN ACCORDANCE WITH THE PROPOSED DRAINAGE LAYOUT PRIOR TO REMOVING EXISTING DOWNSTREAM DRAINAGE

DAMAGED LENGTH OF EXISTING 225 DIAMETER PIPE TO BE REMOVED AND REPLACED WITH NEW LENGTH OF PIPEWORK. LENGTH OF DAMAGED PIPE UNKNOWN. TO BE CONFIRMED ON SITE.  
LOCATION OF NEW SURFACE WATER MANHOLE (SW) SWM420 TO BE LOCATED ADJACENT DAMAGED LENGTH OF PIPEWORK

DRAWING ISSUED FOR DISCHARGE OF PLANNING CONDITIONS

PT	PRELIMINARY ISSUE	14/05/20	MB
REV	AMENDMENTS	DATE	BY/IS
STATUS: <b>PRELIMINARY</b>			
<p><b>Sleater &amp; Watson</b>          Consulting Civil &amp; Structural Engineers.          Ribbles House, Meanygate,          Bamber Bridge, Preston, PR5 6UP          Telephone: 01772 821044          E-mail: admin@sleaterwatson.co.uk          Website: www.sleaterwatson.co.uk</p>			
CLIENT: <b>BAE SYSTEMS</b>			
PROJECT: <b>MODULAR BUILDING, (CEB REPLACEMENT), BAE SYSTEMS, SAMLESBURY.</b>			
SITE: <b>EXISTING DRAINAGE LAYOUT SHOWING DRAINAGE TO BE REMOVED.</b>			
DRAWN	CHECKED	DATE	PROJECT No. SCALE/BD
SAW	GLW	MAY 2020	225011 1:125
DRG No: <b>CEB-SAW-XX-00-52-DR-C-5211-S0-P1</b>			

**EXISTING FOUL AND SURFACE WATER DRAINAGE LAYOUT**  
SCALE 1:125