



KEY

- PLANNING RED LINE BOUNDARY. AREA = 6162M²
- - - CATCHMENT AREA. AREA = 482M²
- DENOTES IMPERMEABLE AREA WITHIN PLANNING BOUNDARY DISCHARGING INTO PROPOSED DRAINAGE SYSTEM. TOTAL = 3092M²
- DENOTES IMPERMEABLE AREA WITHIN PLANNING BOUNDARY DISCHARGING INTO SEPARATE EXISTING DRAINAGE SYSTEM WITHIN AT OR BEYOND THE RED LINE BOUNDARY. TOTAL = 2116M²
- DENOTES IMPERMEABLE AREA OUTSIDE PLANNING BOUNDARY DISCHARGING INTO EXISTING DRAINAGE SYSTEM. TOTAL = 79M²
- DENOTES PERMEABLE AREAS. TOTAL = 180M²

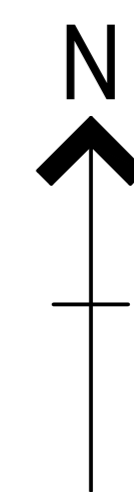

GENERAL NOTES

1. THIS DRAWING IS TO BE READ IN CONJUNCTION WITH ALL RELEVANT SLEATER & WATSON LLP DRAWINGS AND SPECIFICATIONS ALONG WITH ALL ARCHITECTURAL AND MECHANICAL & ELECTRICAL ENGINEERING CONTRACT DOCUMENTS. WHERE DWG, REFIT AND/OR 'E' FILES ARE SUPPLIED, THESE ARE FOR COLLABORATION WITH OTHER CONSULTANTS' INFORMATION AND SHOULD NOT BE USED FOR CONSTRUCTION PURPOSES BY THE CONTRACTOR, SUB-CONTRACTORS OR CLIENT. ONLY THE INFORMATION PROVIDED IN HARD COPY OR PDF FORMAT DRAINAGE IS TO BE RELIED UPON FOR ACCURACY.
2. ALL LEVELS ARE SHOWN IN METRES AND RELATE TO ORDNANCE DATUM.

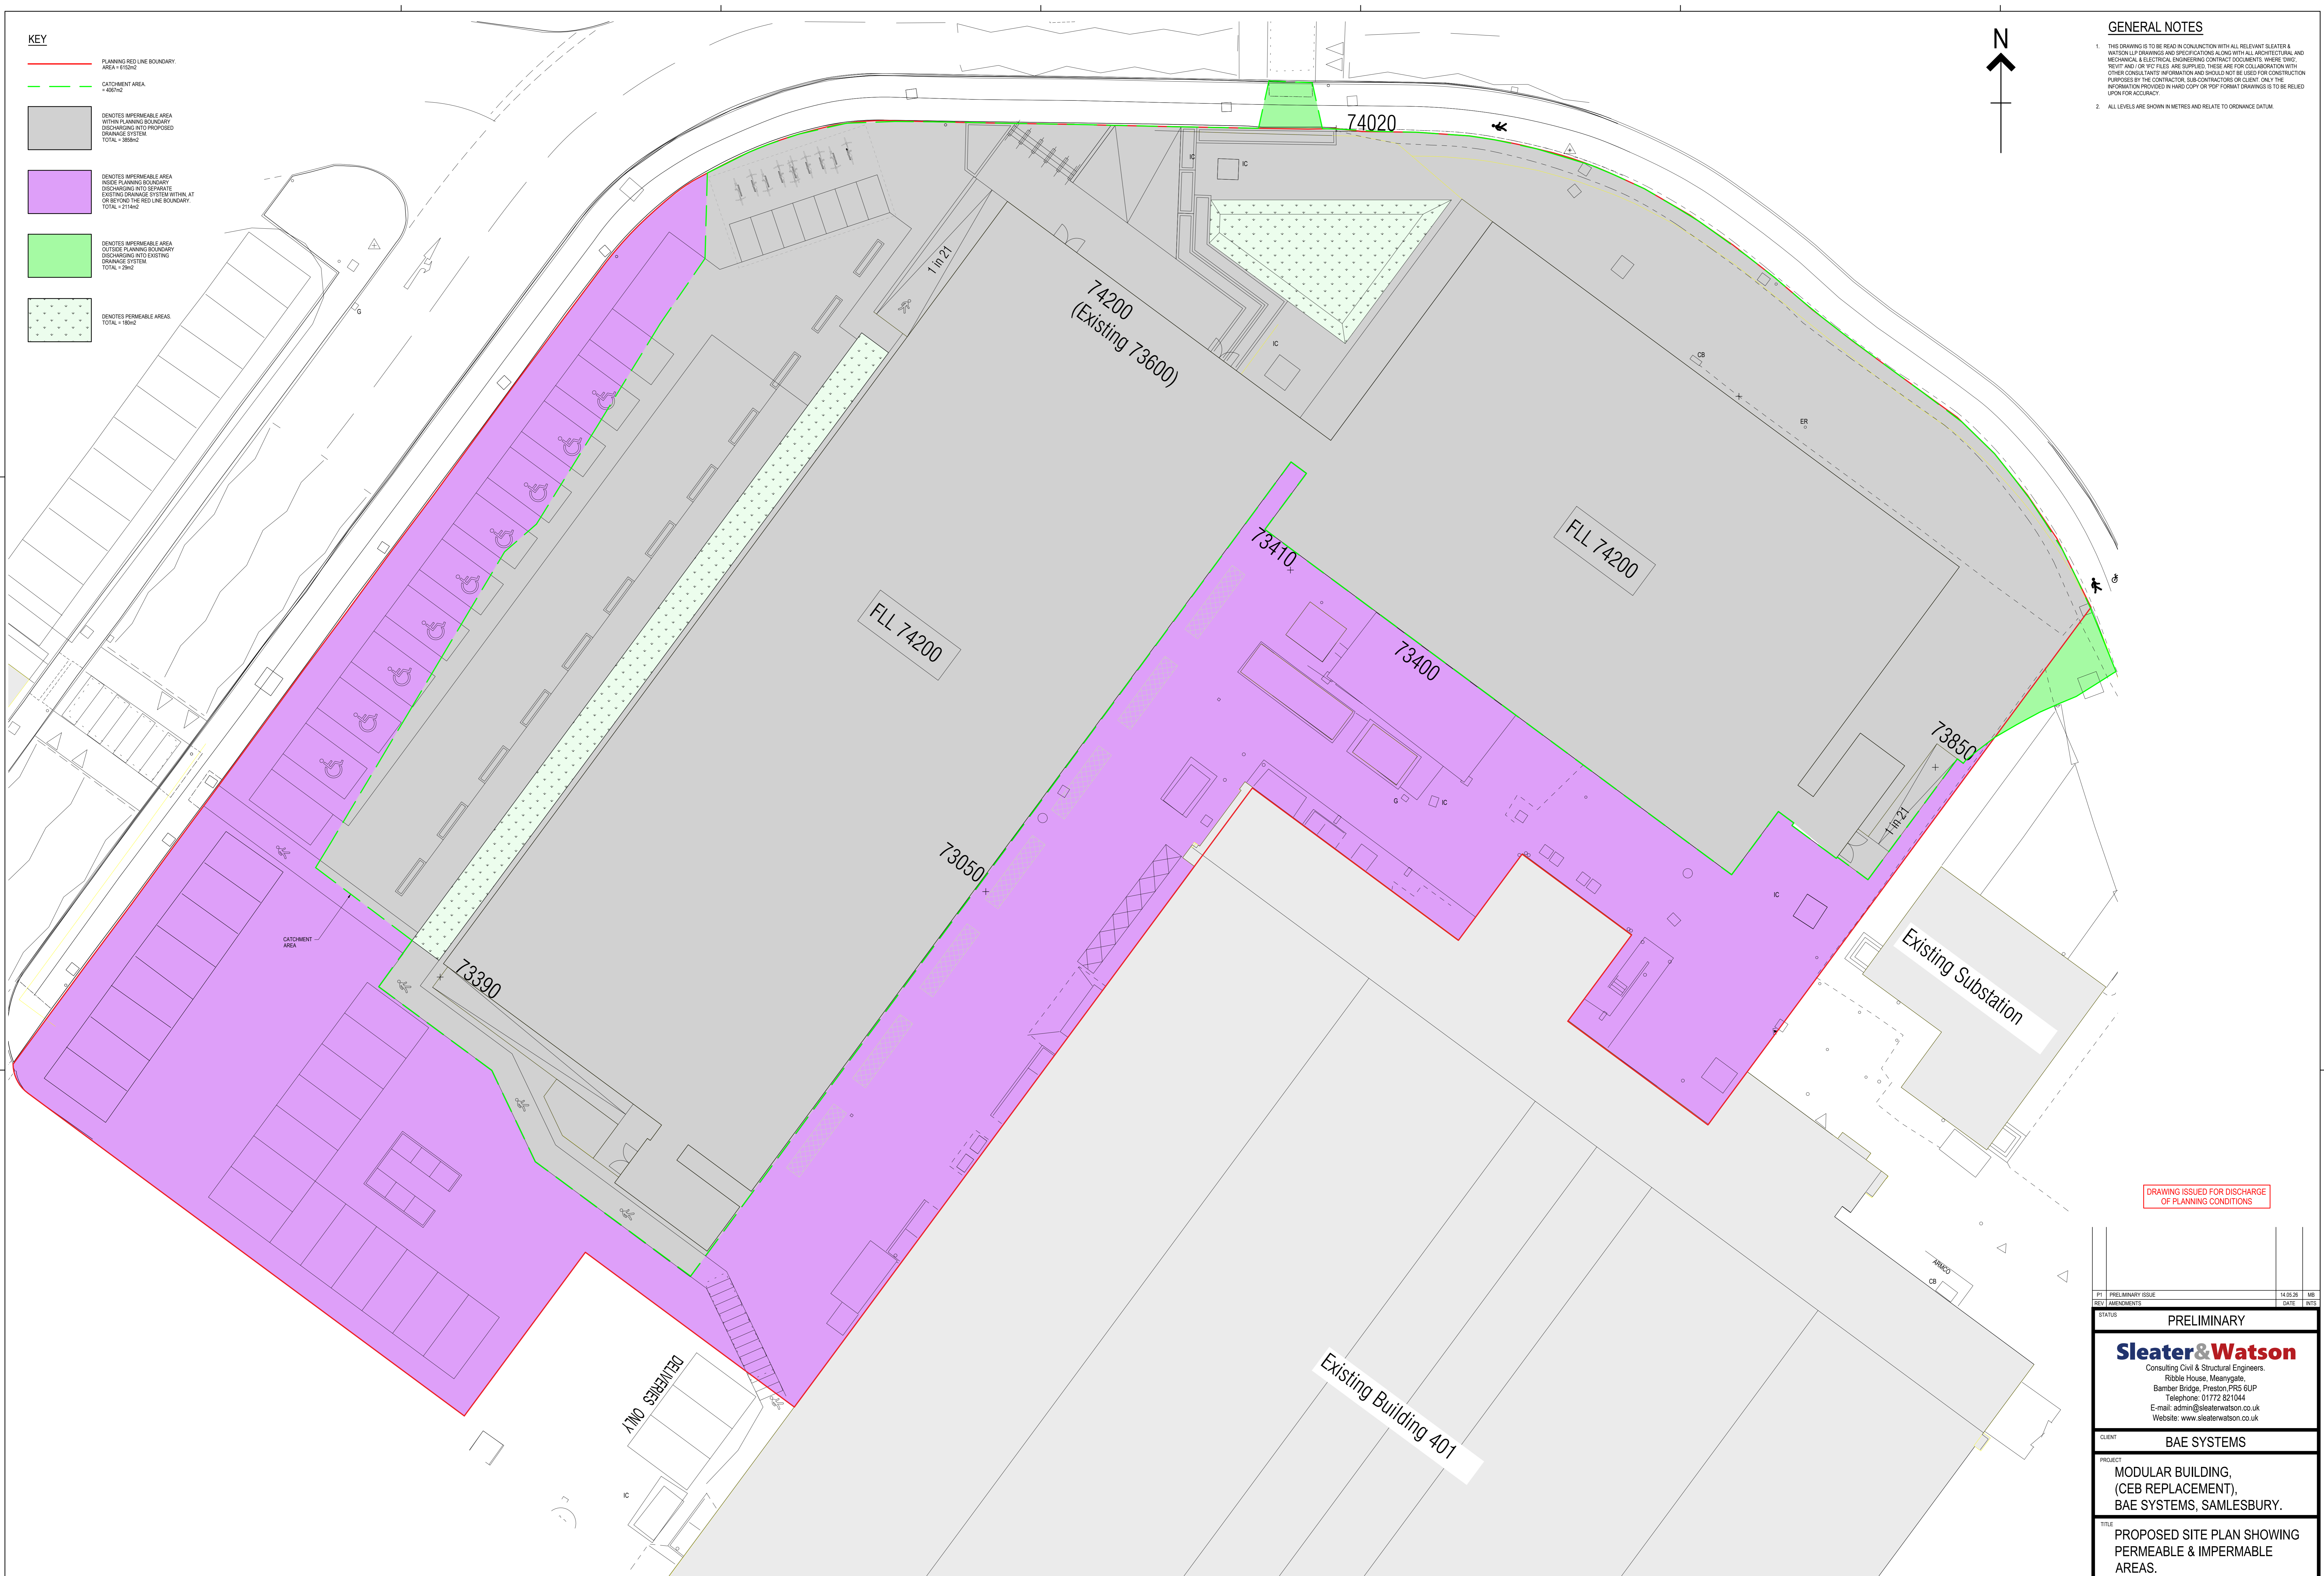

DRAWING ISSUED FOR DISCHARGE OF PLANNING CONDITIONS

PT PRELIMINARY ISSUE 14.05.20 MB REV AMENDMENTS DATE REFS	
PRELIMINARY	
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BAE SYSTEMS	
PROJECT MODULAR BUILDING, (CEB REPLACEMENT), BAE SYSTEMS, SAMLESBURY.	
TITLE PROPOSED SITE PLAN SHOWING PERMEABLE & IMPERMEABLE AREAS.	
DRAWN MB CHECKED GJW DATE MAY 2020 PROJECT NO 225011 SCALE BAO 1:125	ORG NO CEB-SAW-XX-00-52-DR-C-5212-S0-P1

PLAN AS PROPOSED SHOWING IMPERMEABLE / PERMEABLE AREAS DISCHARGING INTO SURFACE WATER SYSTEM
SCALE 1:125